


RURAL ALL-PURPOSE DUAL CARRIAGEWAY WESTBOUND CARRIAGEWAY 1.5 M HIGH VISUAL SCREEN DECK AXIS (SEE NOTE 7) VEHICLE PARAPET **VEHICLE PARAPET** LINEAR DECK DRAINAGE 3.00% CONCRETE SHAPED PIER **GROUND LEVEL** PILED FOUNDATION

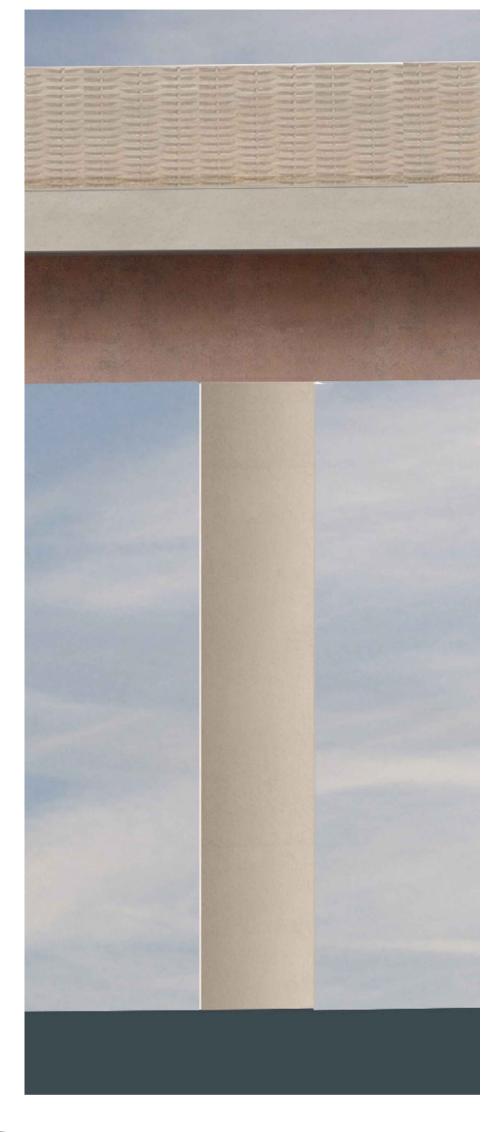


B WEATHERING STEEL & VISUAL SCREEN (DECK & BARRIER CLADDING)







Materials Palette

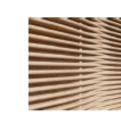

Visual Screen to South elevation Abstraction of woven pattern in GRC. Woven pattern to both faces. This concept will be developed at the next design stage to achieve a more naturalistic, less consistent visual quality (TQ2A3.2)



Twin Girders Weathered steel, bespoke colour.





Edge Treatment Concrete, smooth finish, warm colour.





Concrete Piers Concrete, smooth finish, warm colour.



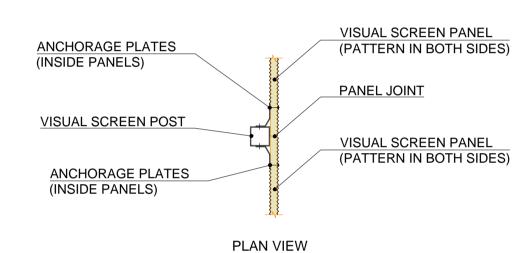

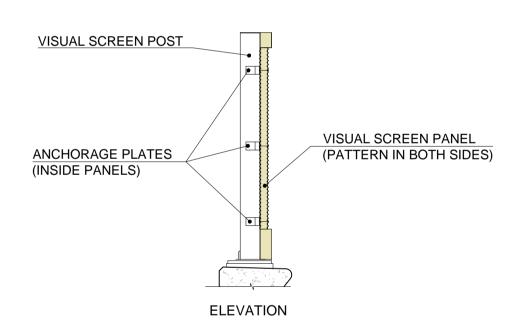

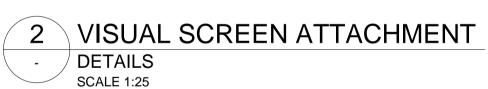

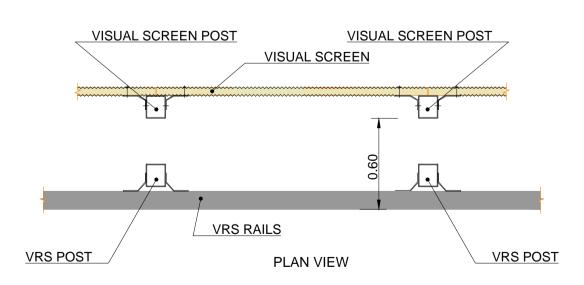




MILLIMETRES SCALE 1:50

NOTES:

- 1. ALL DIMENSIONS ARE IN METRES UNLESS NOTED OTHERWISE.
- 2. EXCEPT FOR FIGURED DIMENSIONS, THE DESIGN SHOWN IN THIS DRAWING IS INDICATIVE AND WILL BE ADJUSTED IN SUBSEQUENT STAGES OF DEVELOPMENT.
- 3. THE DIMENSIONS OF THE FOUNDATIONS SHOWN IN THIS DRAWING ARE ILLUSTRATIVE AND SHALL BE DESIGNED AT A SUBSEQUENT SUBMISSION. THE LOCATIONS OF THE PIERS AND FOUNDATIONS WILL BE A MINIMUM 8 M OUTSIDE OF THE BOUNDARY OF THE RIVER TILL SECTION OF THE RIVER AVON SPECIAL AREA OF CONSERVATION.
- 4. DECK AND PIER SECTIONS SHOWN IN THIS DRAWING ARE INDICATIVE. THIS DRAWING SHALL BE READ IN CONJUCTION WITH CROSS SECTION DRAWINGS.
- 5. CHAINAGES SHOWN IN THIS DRAWING REFERRED TO THE CENTRAL AXIS BETWEEN DECKS (ALIGNMENT AXIS)
- 6. DRAINAGE STRATEGY: ACCORDING TO THE OEMP AND TECHNICAL REQUIREMENTS, WATER WILL BE COLLECTED IN THE LOWER SIDE OF THE DECK BY MEANS OF COLLECTORS AND DRIVEN TO THE A-01N AND A-01S ABUTMENTS WHERE WILL BE DISCHARGED TO THE PIPE DRAINAGE SYSTEM. COLLECTORS AND DISTANCE AMONG THEM TO BE CONFIRMED AT LATER DESIGN STAGES.
- 7. THE ATTACHMENT OF THE VISUAL SCREEN TO THE DECK SHALL BE THROUGH DEDICATED POSTS INDEPENDENT OF THE VEHICULAR PARAPET. POSTS OF VEHICULAR PARAPET AND VISUAL SCREEN KEEP ALIGNED PARALLEL TO THE EDGE OF THE DECK AND INSTALLED ALTERNATIVELY

P02	08/02/21	FOR QUALITY SUBMISSION - 09 FEB 2021	MP	JC	JC	AF
P03	21/03/21	FOR QUALITY SUBMISSION - 23 MAR 2021	MP	MP	MP	РВ
Rev	Rev. Date	Purpose of revision	Drawn	Checkd	Rev'd	Apprv'd

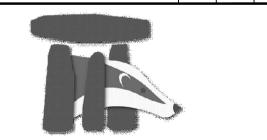



Amesbury to Berwick Down

RIVER TILL VIADUCT **DETAILS**

S4 - Suitable for Stage Approval

	State Code	Preliminary	
	Project Stage	PCF Stage 5	
	Scale	1:50	DO NOT SCALE
	Jacobs No.	HE551506	Rev DO2
	Client no.	HE551506	P03
000	Drawing number		

-DR-S-0004 Z1BRT00Z

Reproduced by permission of Ordnance Survey on behalf of HMSO. © Crown copyright and database right 2019. All rights reserved. Ordnance Survey Licence number 100030649.

5 DRAINAGE JOINT DETAIL

A PIER FRONT VIEW

SCALE 1:50

