
SHRUB END CLINIC, COLCHESTER

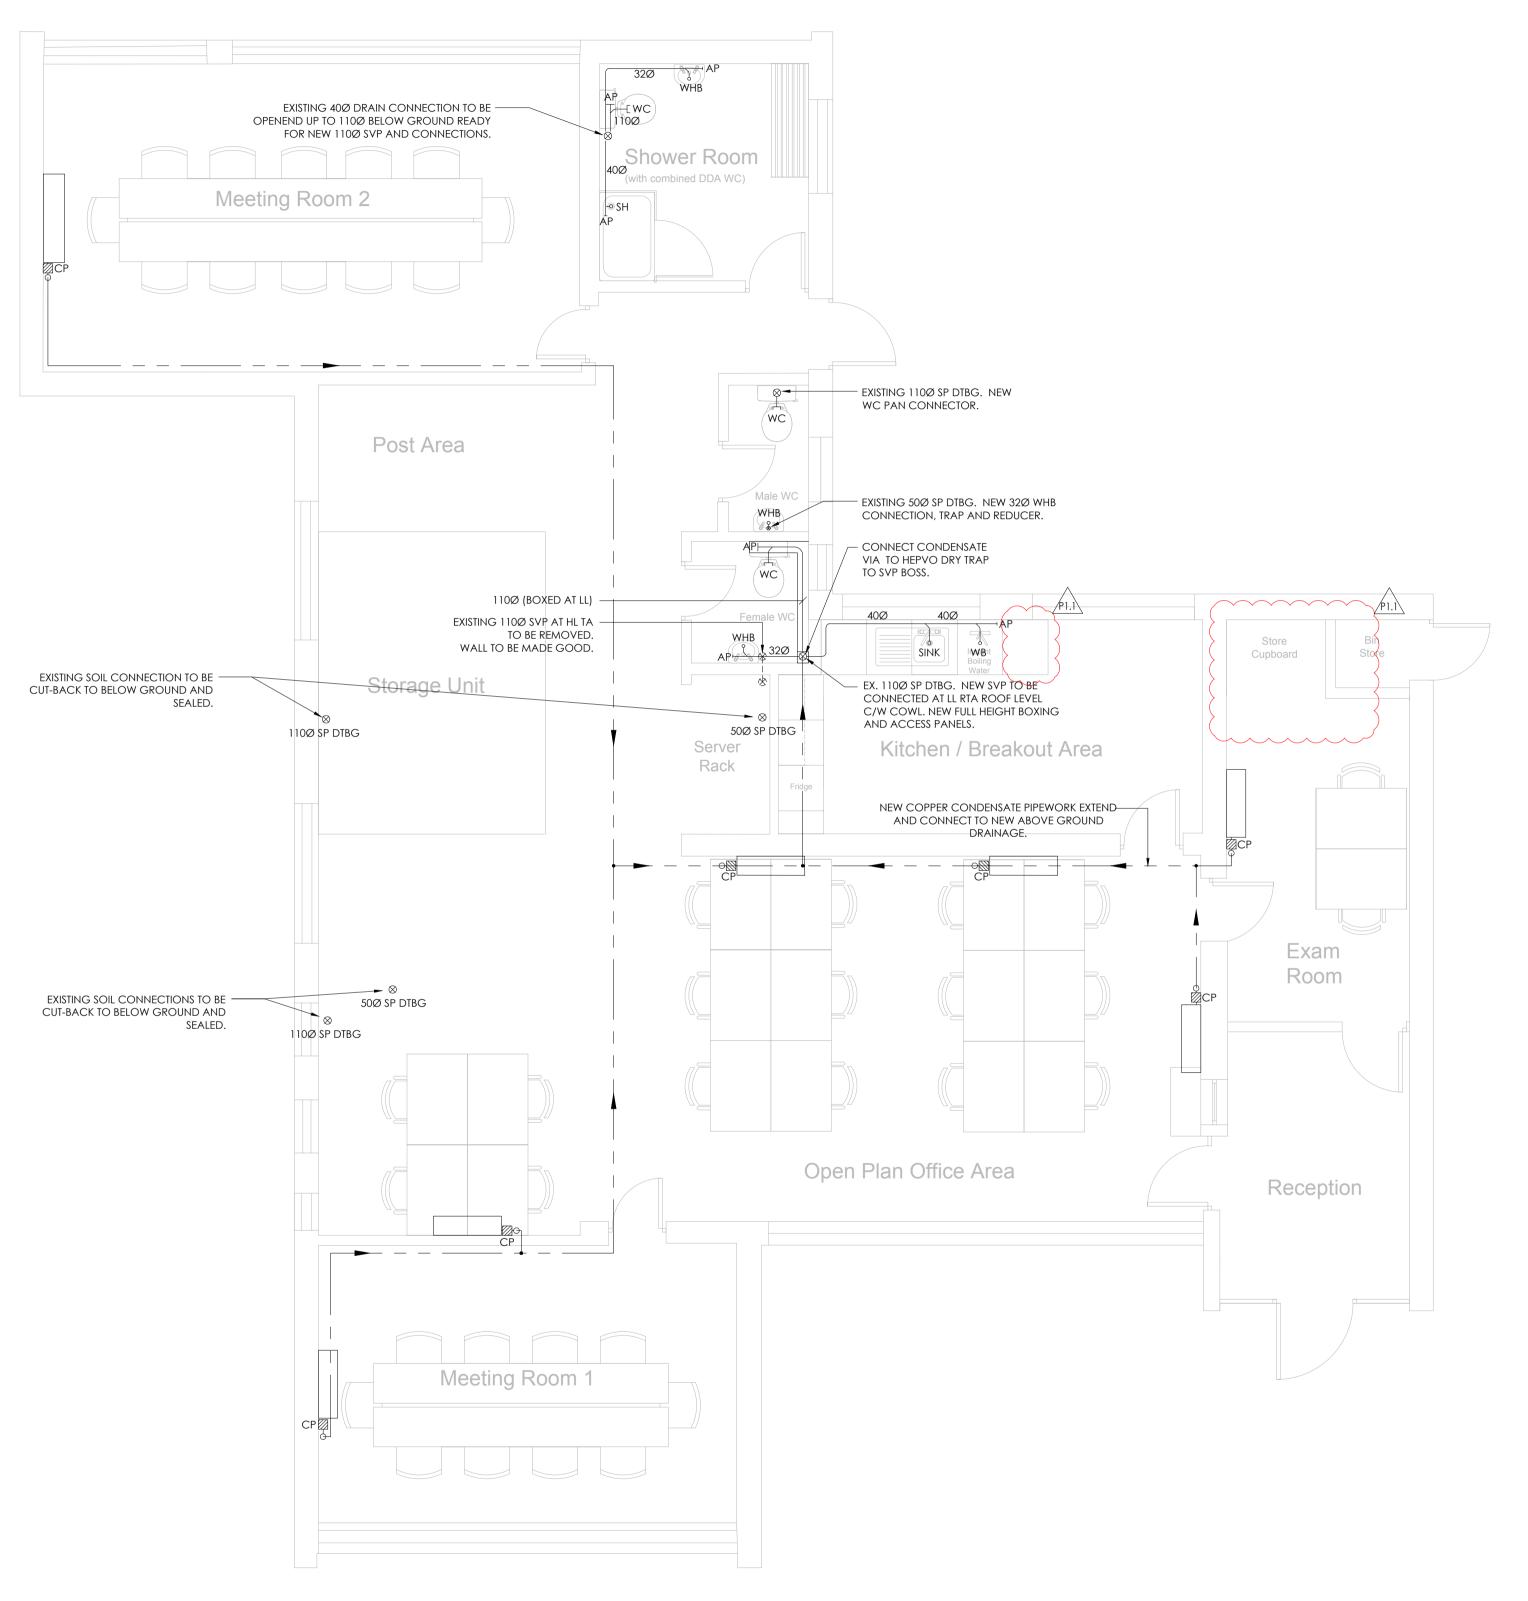

PROPOSED ABOVE GROUND DRAINAGE LAYOUT
Scale: 1:50

- WASH HAND BASIN TO INCLUDE 32Ø WHITE PVC WASTE CONNECTION WITH BOTTLE TRAP AND ANTI-SYPHON VALVE.
- SHOWER TO INCLUDE 40Ø WHITE PVC WASTE CONNECTION WITH SHALLOW TRAP.
- SINK TO INCLUDE 40Ø WHITE PVC WASTER CONNECTION WITH P-TRAP.
- WC TO INCLUDE 110Ø WHITE PVC WASTE WITH PAN CONNECTION TO SUIT WC
- TRAP.

 CONDENSE DISCHARGE TO INCLUDE 40ØWHITE PVC WASTE CONNECTION WITH

HEPWORTH H20 WATERLESS TRAP AND TUNDISH.

DISHWASHER TO INCLUDE - 40Ø WHITE PVC WASTE CONNECTION WITH TUBULAR

NOTES:

- DRAINAGE DESIGN BASED ON BS EN 12056-2:2000 FOR DRAINAGE UNITS (SYSTEM III), FREQUENCY OF USE AND FLOW RATE CALCULATIONS.
- 2. DRAINAGE TO BE INSTALLED TO BS EN 12056-2:2000 AND BUILDING REGULATIONS PART H: DRAINAGE AND WASTE DISPOSAL.
- 3. ABOVE GROUND DRAINAGE PIPEWORK TO BE MARLEY PUSH FIT OR EQUAL AND APPROVED.
- 4. FIRE COLLARS AND/OR PIPEWRAP WHERE SERVICES PENETRATE COMPARTMENT WALLS. CONTRACTOR TO CONSULT ARCHITECT FOR LOCATIONS FOR FIRE COMPARTMENT WALLS.

STANDARDS AND REGULATIONS

THERMOPLASTICS PIPE SYSTEMS.

BS EN 1329-1: 2014 - PLASTICS PIPING SYSTEMS FOR SOIL AND WASTE DISCHARGE (LOW AND HIGH TEMPERATURE) WITHIN THE BUILDING STRUCTURE – PVCU.

BS EN 1451-1: 2000 - PLASTICS PIPING SYSTEMS FOR SOIL AND WASTE DISCHARGE (LOW AND HIGH TEMPERATURE) WITHIN THE BUILDING STRUCTURE - POLYPROPYLENE.

BS EN 1519-1: 2000 - PLASTICS PIPING SYSTEMS FOR SOIL AND WASTE DISCHARGE (LOW AND HIGH TEMPERATURE) WITHIN THE BUILDING STRUCTURE - POLYETHYLENE.

BS 4514: 2001 - SPECIFICATION FOR PVCU SOIL AND VENTILATING PIPES, FITTINGS AND

ACCESSORIES.

BS EN 1566-1: 2000 - SPECIFICATION FOR THERMOPLASTICS WASTE PIPE AND FITTINGS.

BS 5255: 1989 - SPECIFICATION FOR THERMOPLASTICS WASTE PIPE AND FITTINGS.

BS 5627: 1984 - SPECIFICATION FOR PLASTICS CONNECTORS FOR USE WITH HORIZONTAL OUTLET VITREOUS CHINA WC PANS.

BS EN 14680: 2006 - SPECIFICATION FOR ADHESIVES FOR NON-PRESSURE

BS EN 681-1: 1996 - ELASTOMERIC SEALS. MATERIAL REQUIREMENTS FOR PIPE JOINT SEALS USED IN WATER AND DRAINAGE APPLICATIONS. PART 1 VULCANISED RUBBER.

BS EN ISO 9001: 2008 - QUALITY SYSTEMS. MODEL FOR QUALITY ASSURANCE IN DESIGN, DEVELOPMENT, PRODUCTION, INSTALLATION AND SERVICING.

THE DETAILS DEPICTED ON THIS DRAWING ARE THE COPYRIGHT TO CREATE CONSULTING ENGINEERS LTD AND MAY NOT BE REPRODUCED WITHOUT PERMISSION. THIS DRAWING MUST NOT BE RE-ISSUED, LOANED OR COPIED WITHOUT THE CONSENT. ERRORS OMISSIONS AND DISCREPANCIES SHOULD BE REPORTED TO THE ORIGINATOR IMMEDIATELY.

ALL DIMENSIONS TO BE CHECKED BEFORE SITE OR OFF-SITE FABRICATION BY THE CONTRACTOR, HIS SUB-CONTRACTOR OR SUPPLIER.

DO NOT SCALE PLANS - USE FIGURE OR GRID DIMENSIONS WHERE GIVEN. ANY DEVIATION FROM THE DRAWING IS TO BE REPORTED TO THE ORIGINATOR IMMEDIATELY.

STRUCTURE, STRUCTURAL MEMBERS & GEOTECHNICAL INVESTIGATIONS ARE TO BE CARRIED OUT & APPROVED BY THE APPOINTED STRUCTURAL ENGINEER. ANY DEVIATIONS TO THESE ELEMENTS ARE TO BE REPORTED TO THE APPOINTED CONSULTANT IMMEDIATELY.

IF IN DOUBT ASK!

NOTES:



IN ADDITION TO THE HAZARDS / RISKS NORMALLY ASSOCIATED WITH THE TYPES OF WORK DETAILED ON THIS DRAWING, THE FOLLOWING DESIGNERS RESIDUAL HAZARDS HAVE BEEN IDENTIFIED AND SHOULD BE ADDRESSED/MANAGED BY THE CONTRACTOR. ANY HAZARDS THAT CANNOT BE ADDRESSED AND REMOVED SHALL BE CARRIED FORWARD AS PART OF THE HEALTH AND SAFETY HANDOVER DOCUMENTATION.

1		<u>HAZARD</u>	DESCRIPTION
ı	1	N/A	N/A
ı	2		
ı			
ı	IT IS ASSUMED THAT ALL WORKS WILL BE CARRIED OUT BY A COMF		WORKS WILL BE CARRIED OUT BY A COMPETENT

CONTRACTOR WORKING, WHERE APPROPRIATE, TO AN APPROVED RISK ASSESSMENT AND METHOD STATEMENT.

P1.1 28/09/2017 CHANGES AS PER MCA REQUESTS NGS JDB

MARITIME & COASTGUARD AGENCY

PROJECT
SHRUB END CLINIC
ICENI WAY
COLCHESTER

DRAWING TITLE
PROPOSED
ABOVE GROUND DRAINAGE LAYOUT
SHEET 01 OF 01

DATE DESIGNED DRAWN CHECKED SCALE(S)

08/08/2017 LE SP JDB 1:50.@A1

CRECTE CONSULTING ENGINEERS LTD

SP JDB 1:50.@A1

NORWICH LONDON CHELMSFORD GLASGOW

15 PRINCES STREET,
NORWICH,
NORFOLK, NR3 1AF,
TEL: 01603 877010

DRAWN CHECKED

DRAWING STATUS

FOR TENDERPROJORIGZONELEVELTYPEROLECLASSPRESEN.NUMBERSTATUSREVISION1321CCE00GFDRP50P0201D2P1.1