

## **Shotton Parish** Council

STATUS: TENDER Design: MD RVT: CJW App'd:MD Chk'd by: CJW Scale: 1:10 Date: Jan 19





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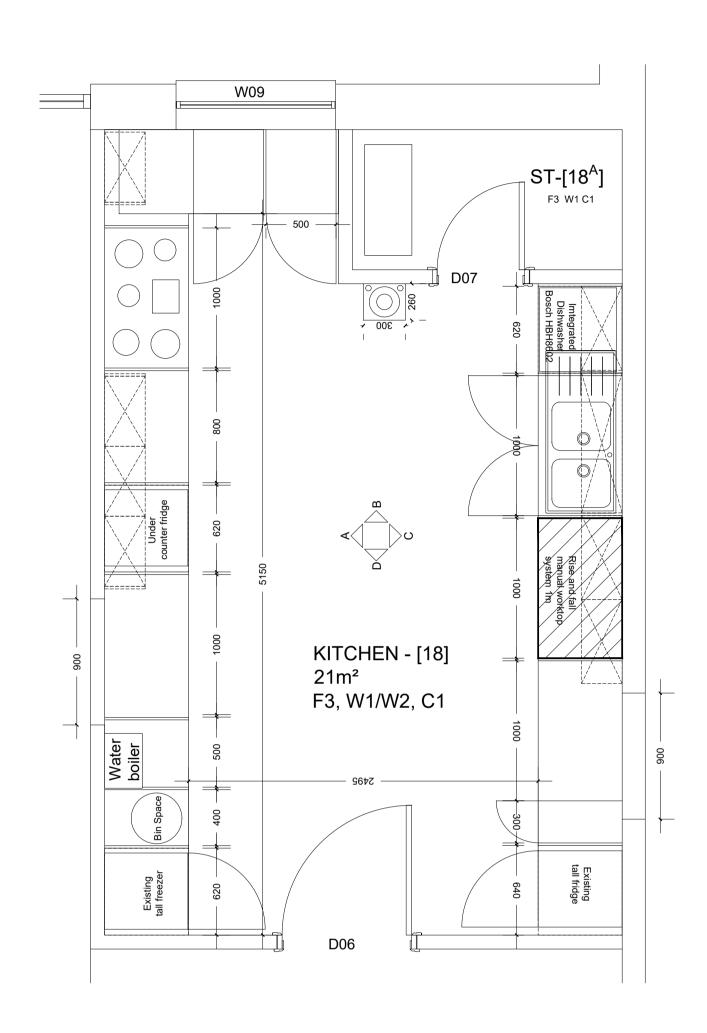
Mallan House, Bridge End, Hexham, Northumberland, NE46 4DQ


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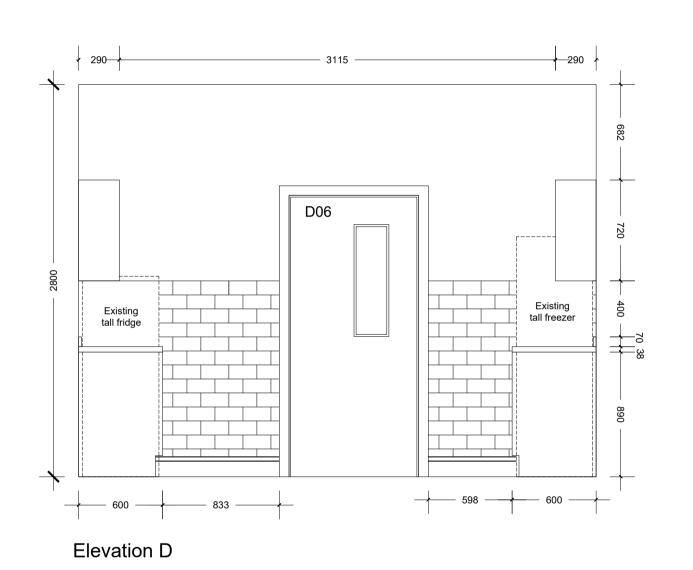
Project no: Drg no: Rev: 1442 A(21)101





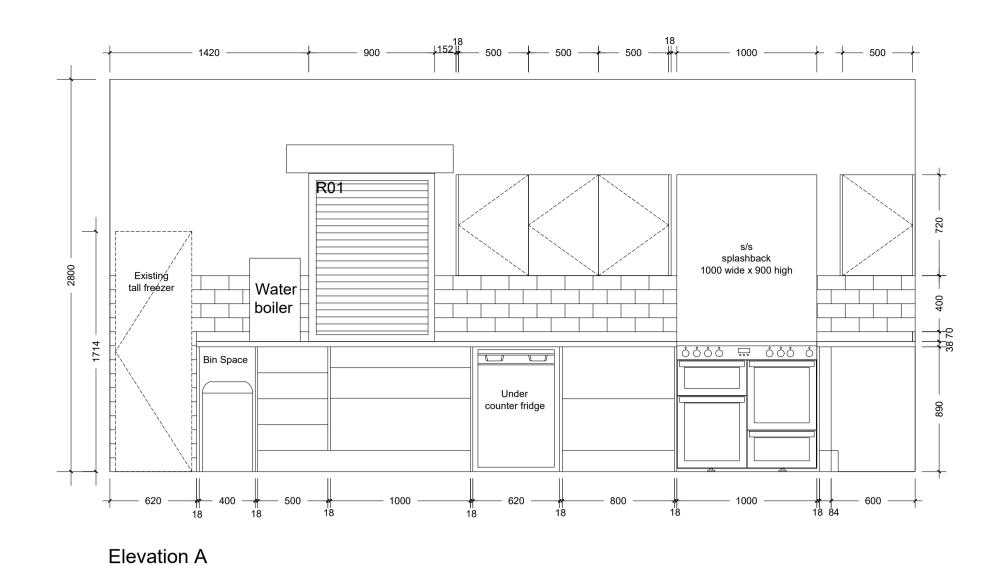

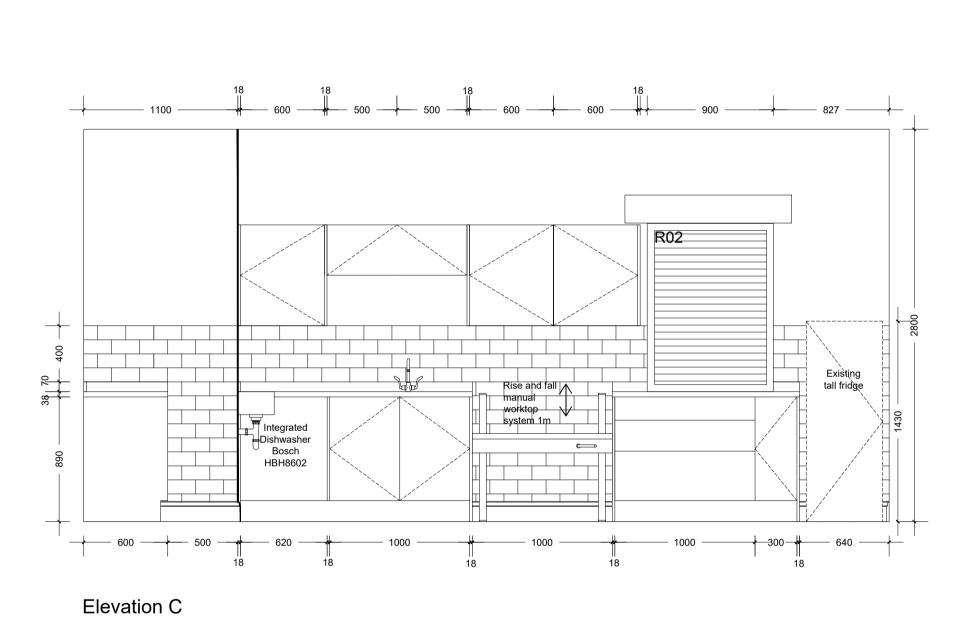

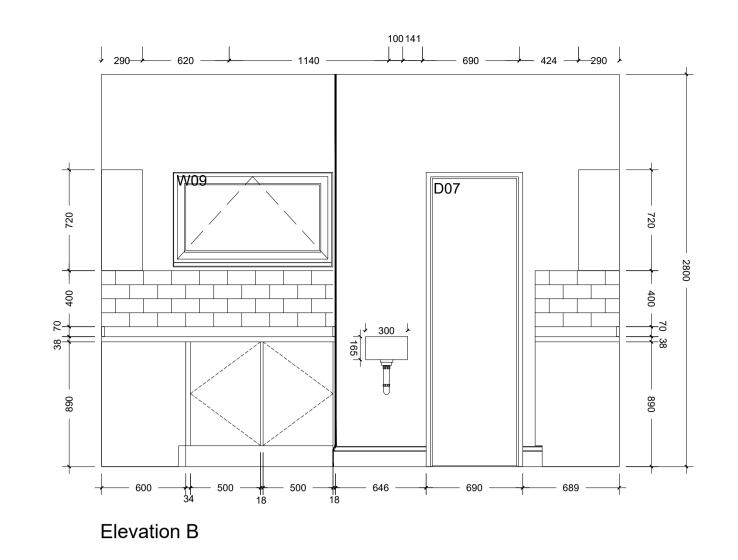

#### **Kitchen Finishes**

**Units:** Howdens Greenwich Ivory

Worktop: Howdens Grey Oak Effect 38mm Square Edge

Worktop 3.6m Length. Ref No: WKP0267

Handles: Chrome Effect T bar handle. Ref No: HKB3201

Floor: Altro Suprema II vinyl safety flooring. Colour TBC

Walls: 3 coats of emulsion on plaster board and skim


Tiles: White ceramic glazed tiles - spec

#### **Appliances by Client:**

- Double toaster
- Microwave 2 no.
- Sandwich maker
- Counter Bain Marie
- Under counter Fridge
- Free standing Fridge
- Free standing Freezer
- Ice cream
- Flavel electric range cooker 13.3 kW (min 40A) Installed by contractor
- Eazyzap Fly killer

#### **Appliances by Contractor:**

- Water Boiler Burco 2lt
- Dishwasher
- Handwash basin
- Cooker hood (recirculating)

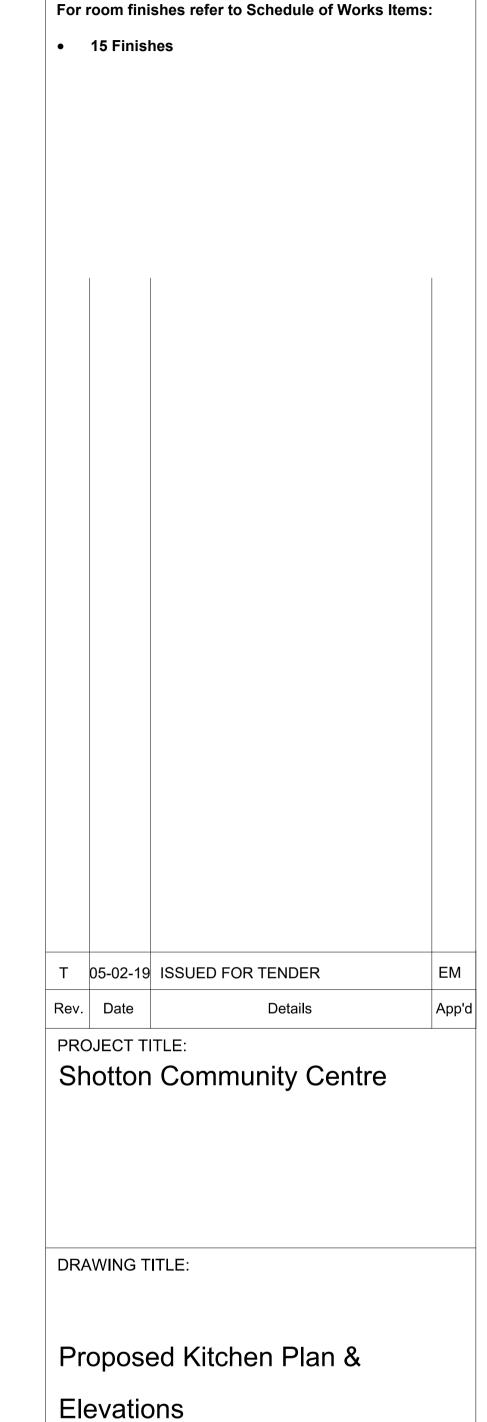

CLIENT:

NOTES.

1. ALL DIMENSIONS IN MILLIMETRES (mm) UNLESS NOTED

3 THIS DRAWING SHOULD BE READ IN CONJUNCTION WITH

2. ALL LEVELS ARE IN METRES (m) ABOVE ORDNANCE

THE GENERAL ARRANGEMENT DRAWING.


#### **Shotton Parish Council**

STATU	s: TENDER		
Design:	MRD	CAD:	EMN
Chk'd:	CW	App'd:	MRD
Date:	Aug 18	Scale:	1:50 @A1



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Drg no: Project no: A(22)01 1442

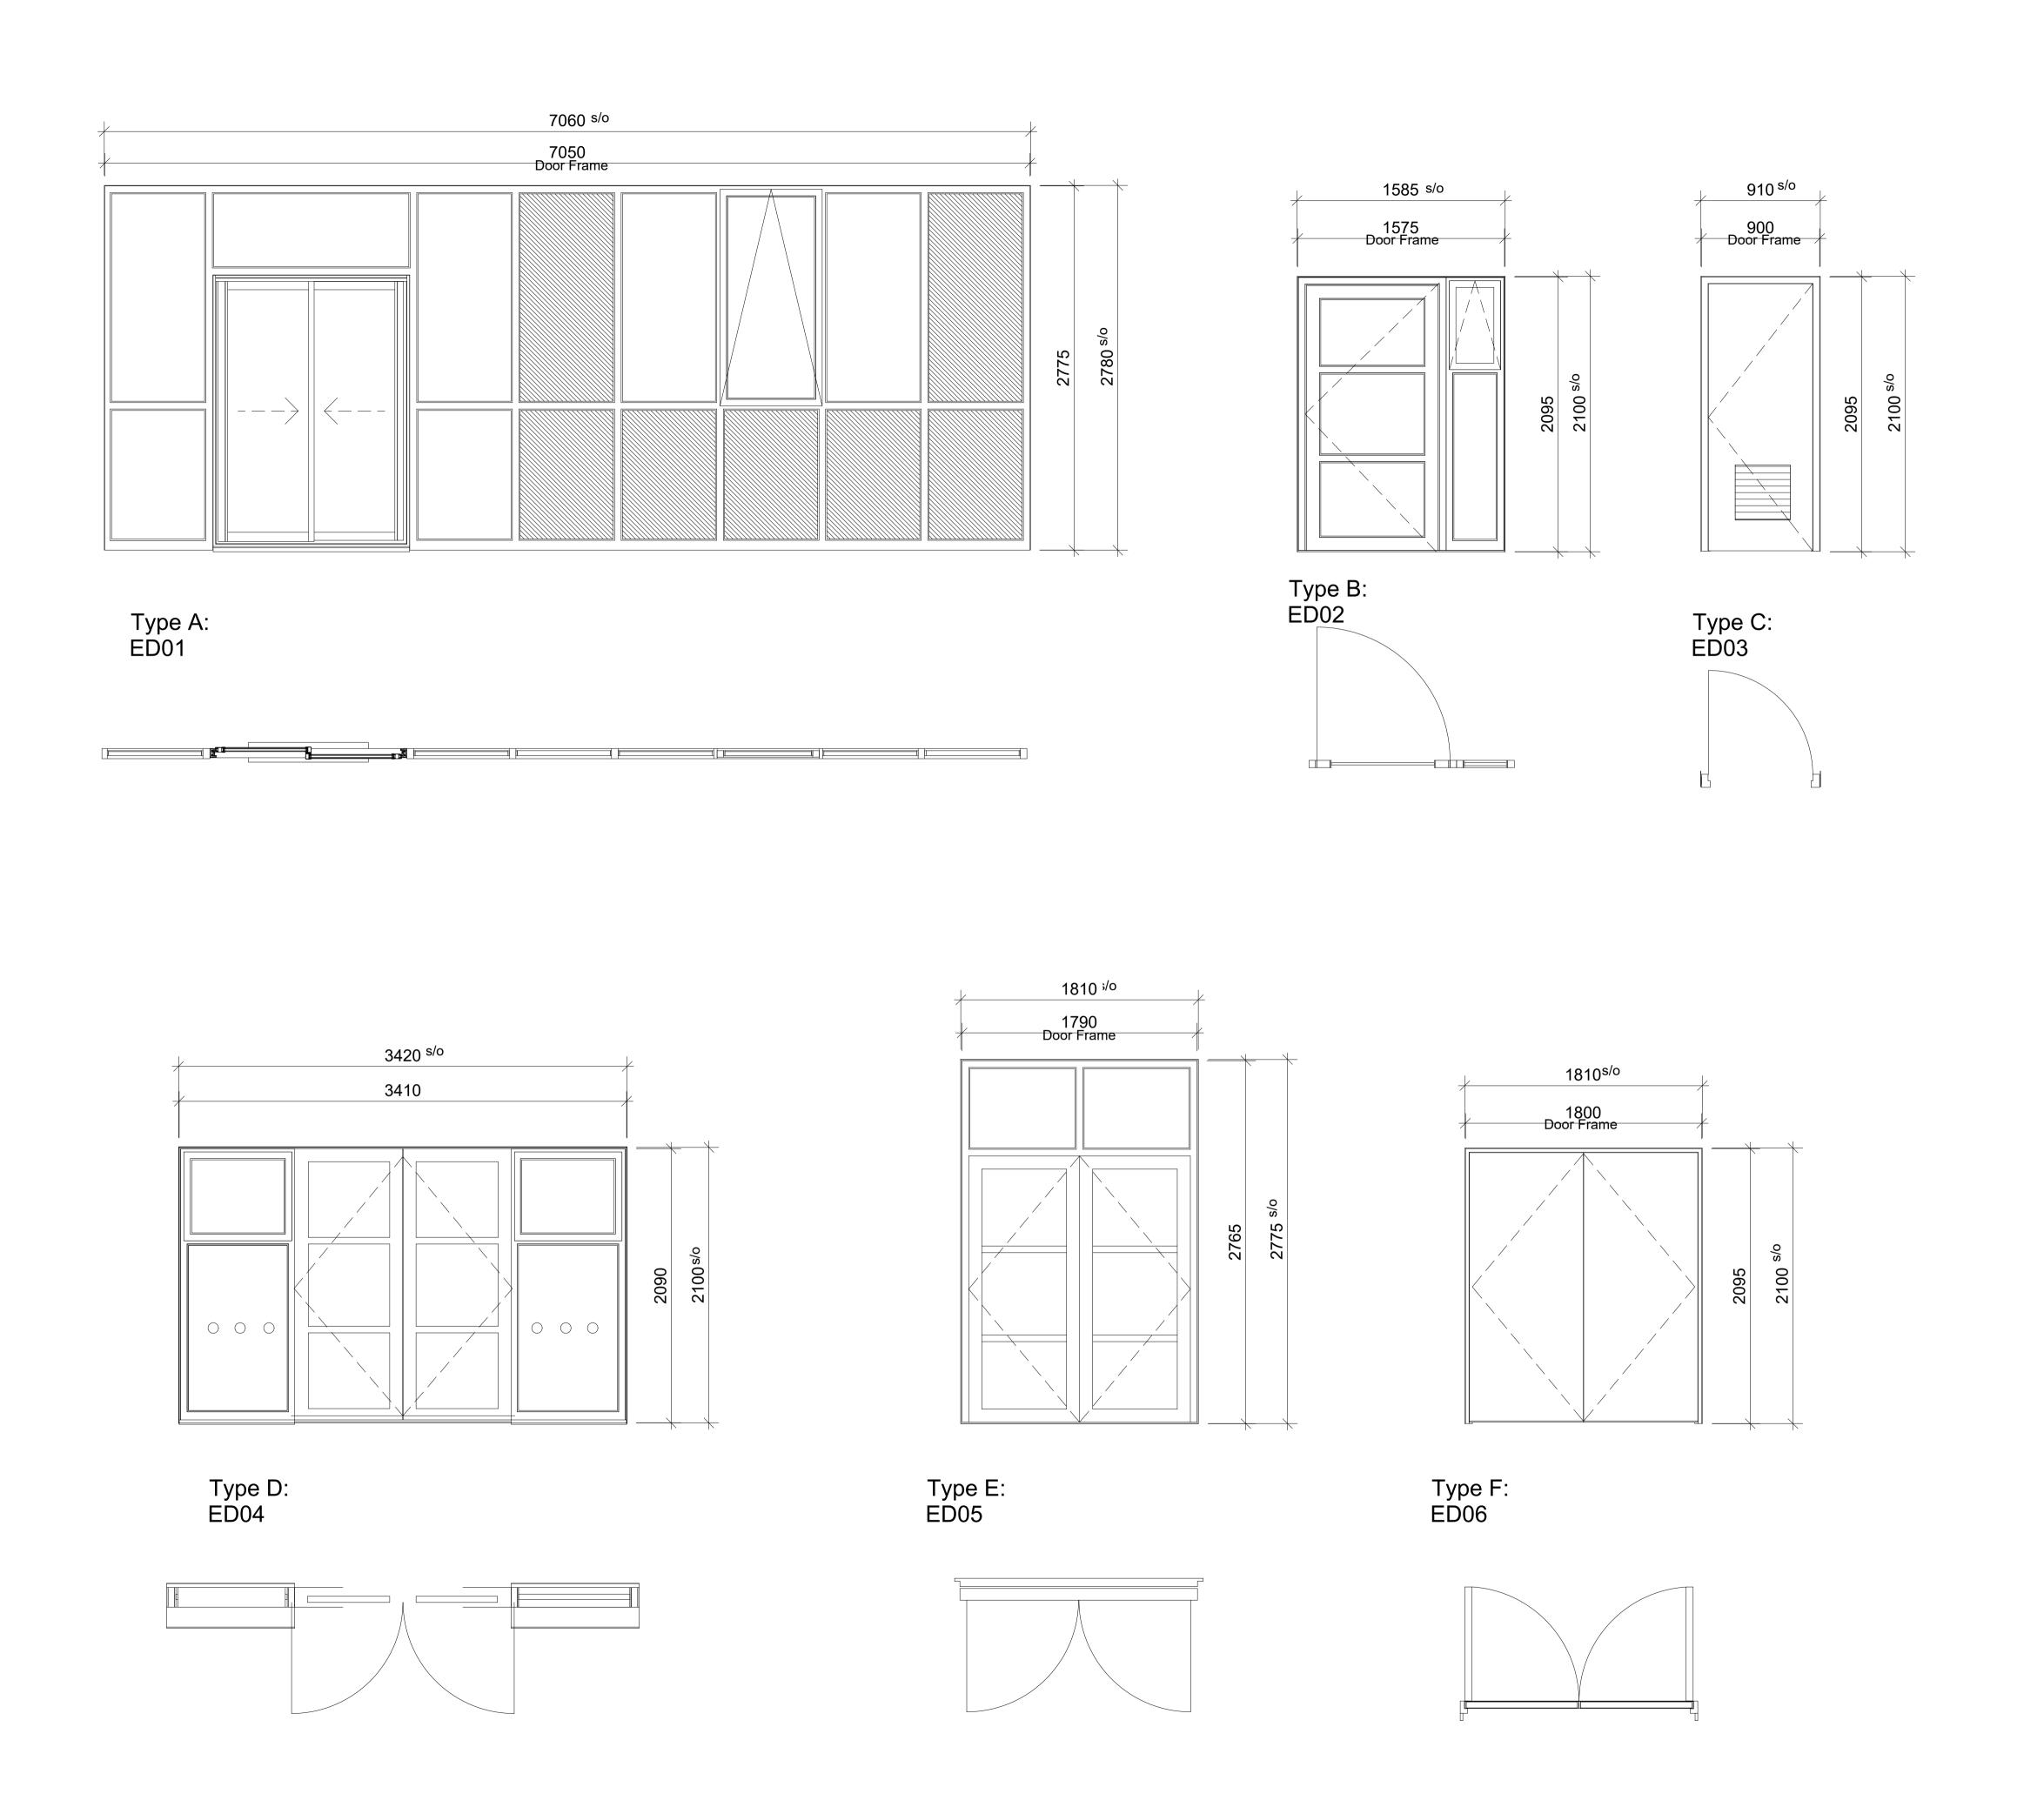

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T 05.02.19 TENDER ISSUE CJW

Rev. Date Detail App'd

PROJECT:

# Shotton Community Centre

DRAWING TITLE:

# Proposed external door drawings

CLIENT:

## **Shotton Parish Council**

TENDER			
Design: MD	RVT:	EMN	
Chk'd by: CJW	App'd:	CJW	
Date: Jan 19	Scale:	1 : 50	(@ A3)




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1442

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Drg No: C(31)01 Rev:



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PROJEC

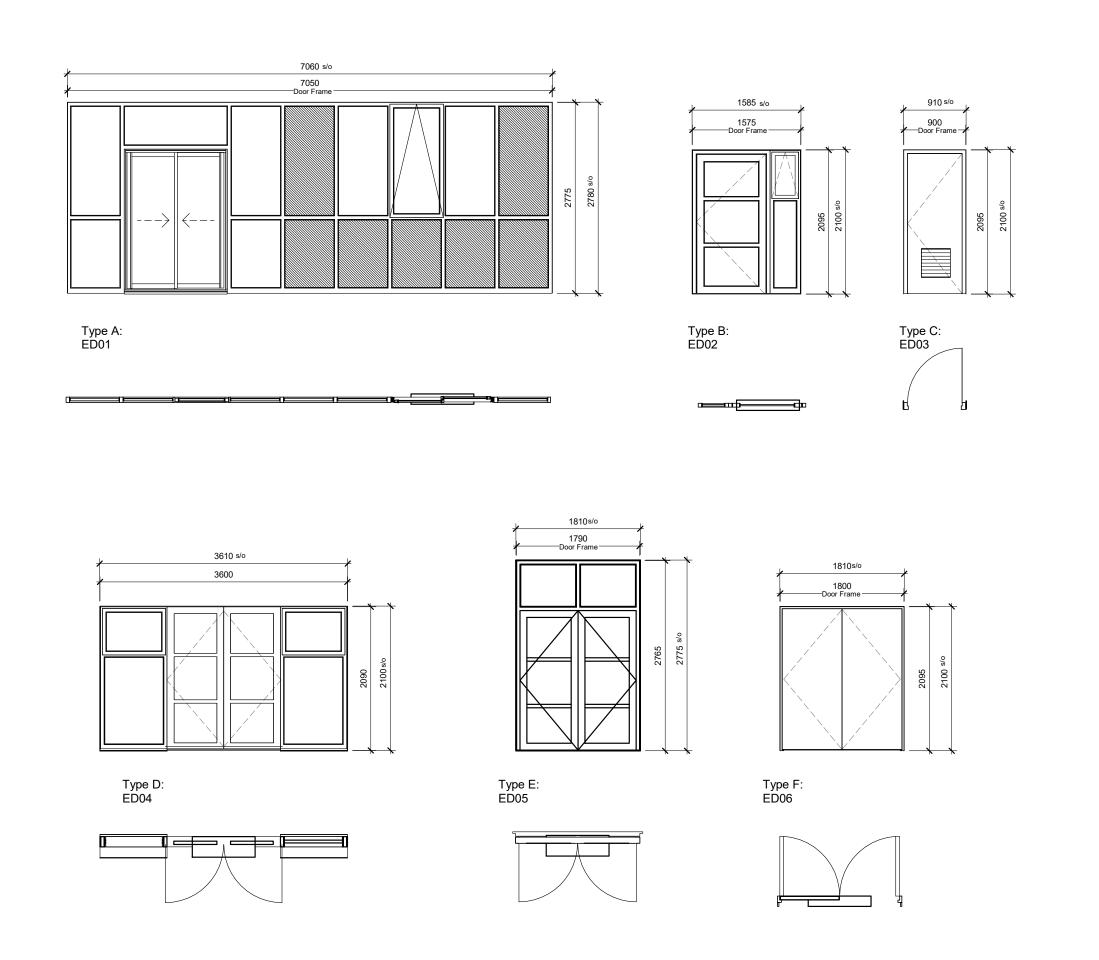Rev. Date

#### Shotton Community Centre

App'd

DRAWING TITLE:

## Proposed external door drawings

CLIENT:


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Date: Jan 19	Scale:	1:50	(@ A3)




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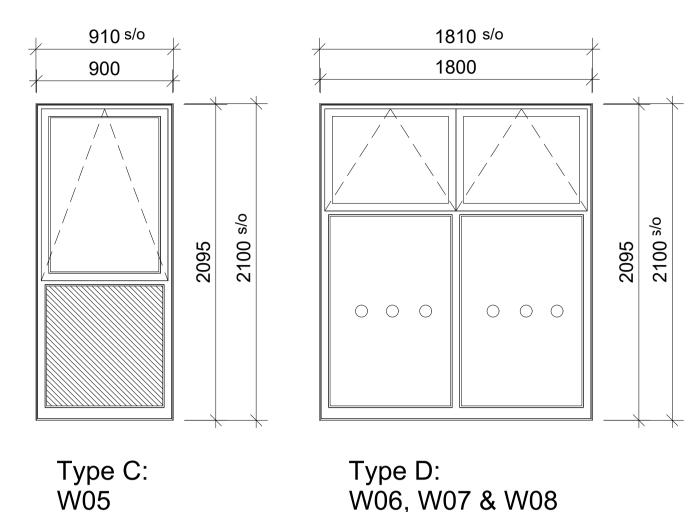
Project no: Drg No: Rev: 1442 C(31)01 T




Window Type - Upvc to RAL 7016 Infill panel colour - RAL 7016

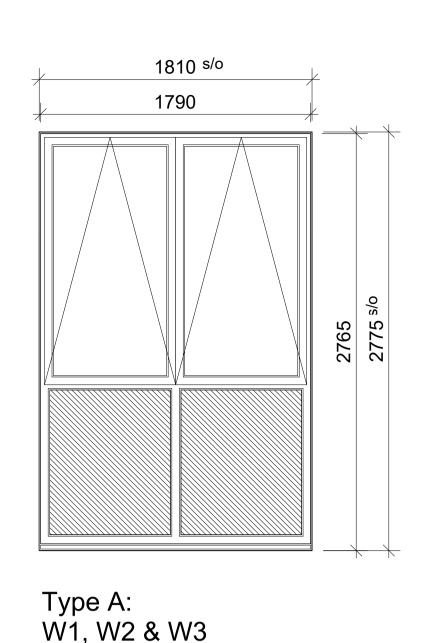W04



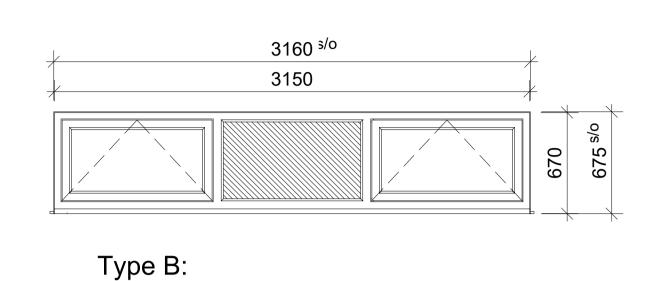

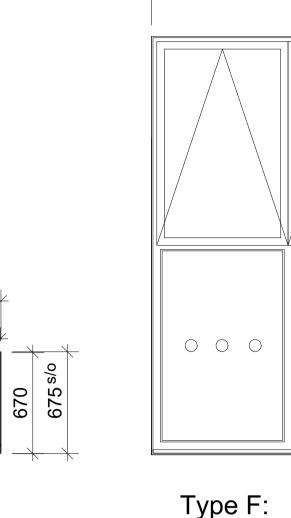

1135 s/o

1125

Type E:

W09

Type F: W10,W11 &W12

 $\circ$   $\circ$   $\circ$ 

1810 s/o

WINDOWS Opening Room Room Type Window size Cill level from FFL Head level from FFL Lintel Type Glazing Type Notes Reference No. Name 0 FFL W01 13 I.T Room 1810x2775 2775 FFL Catnic -CTF5 (Black) Double glazed window Argon filled To provide trickle vents & locks, Window restrictors - Coloured Insulated infill panel <1.5w/m2k - G-Value <1.0 to match frame Double glazed window Argon filled To provide trickle vents & locks, Window 0 FFL 2775 FFL Catnic -CTF5 (Black) W02 13 1810x2775 I.T Room <1.5w/m2k - G-Value <1.0 restrictors - Coloured Insulated infill panel to match frame Double glazed window Argon filled To provide trickle vents & locks, Window Catnic -CTF5 (Black) 1810x2775 I.T Room 13 0 FFL 2775 FFL <1.5w/m2k - G-Value <1.0 restrictors - Coloured Insulated infill panel W03 to match frame Male and Double glazed window Argon filled To provide trickle vents & locks, Window 2775 FFL 10 & 12 2100 FFL В 3160x675 Catnic -CTF5 (Black) <1.5w/m2k - G-Value <1.0 Female W.C. restrictors - Coloured Insulated infill panel W04 to match frame To provide trickle vents & locks, Window Double glazed window Argon filled 0 FFL Catnic -CTF5 (Black) 910x2100 2100 FFL Office 80 <1.5w/m2k - G-Value <1.0 restrictors - Coloured Insulated infill panel W05 to match frame Double glazed window Argon filled To provide trickle vents & locks, D 05 Multi purpose 2 1810x2100 0 FFL 2100 FFL Catnic -CTF5 (Black) W06 <1.5w/m2k - G-Value <1.0 Window restrictors Double glazed window Argon filled | To provide trickle vents & locks, D 1810x2100 05 Multi purpose 2 Catnic -CTF5 (Black) <1.5w/m2k - G-Value <1.0 0 FFL 2100 FFL Window restrictors W07 Double glazed window Argon filled To provide trickle vents & locks, 04 Multi purpose 1 1810x2100 0 FFL D 2100 FFL Catnic -CTF5 (Black) <1.5w/m2k - G-Value <1.0 Window restrictors 80W To provide trickle vents & locks, Double glazed window Argon filled 1135x675 18 Kitchen 1425 FFL 2100 FFL Catnic -CTF5 (Black) Window restrictors <1.5w/m2k - G-Value <1.0 W09 To provide trickle vents & locks, Double glazed window Argon filled 17 Hall 0 FFL 1810x2775 2775 FFL Catnic -CTF5 (Black) Window restrictors <1.5w/m2k - G-Value <1.0 W10 To provide trickle vents & locks, Double glazed window Argon filled 0 FFL Catnic -CTF5 (Black) Hall 1810x2775 2775 FFL 17 W11 Window restrictors <1.5w/m2k - G-Value <1.0 Double glazed window Argon filled To provide trickle vents & locks, Catnic -CTF5 (Black) Hall 1810x2775 0 FFL 17 2775 FFL W12 Window restrictors <1.5w/m2k - G-Value <1.0

Windows to conform to BS PAS 24 of 2012 and any glazing used used should conform to P1A as a minimum standard

Cills to include end caps colour to match frame of windows

Т	31.01.19	TENDER ISSUE	CLDV
Rev.	Date	Detail	App'd

PROJECT:

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## Shotton Community Centre

DRAWING TITLE:

## Proposed window drawing

CLIENT:

## **Shotton Parish Council**

STATUS: TE	ENDER			
Design: MD		RVT:	EMN	
Chk'd by: CJW		App'd:	CJW	
Date: Jan 19		Scale:	1 : 50	(@ A3)



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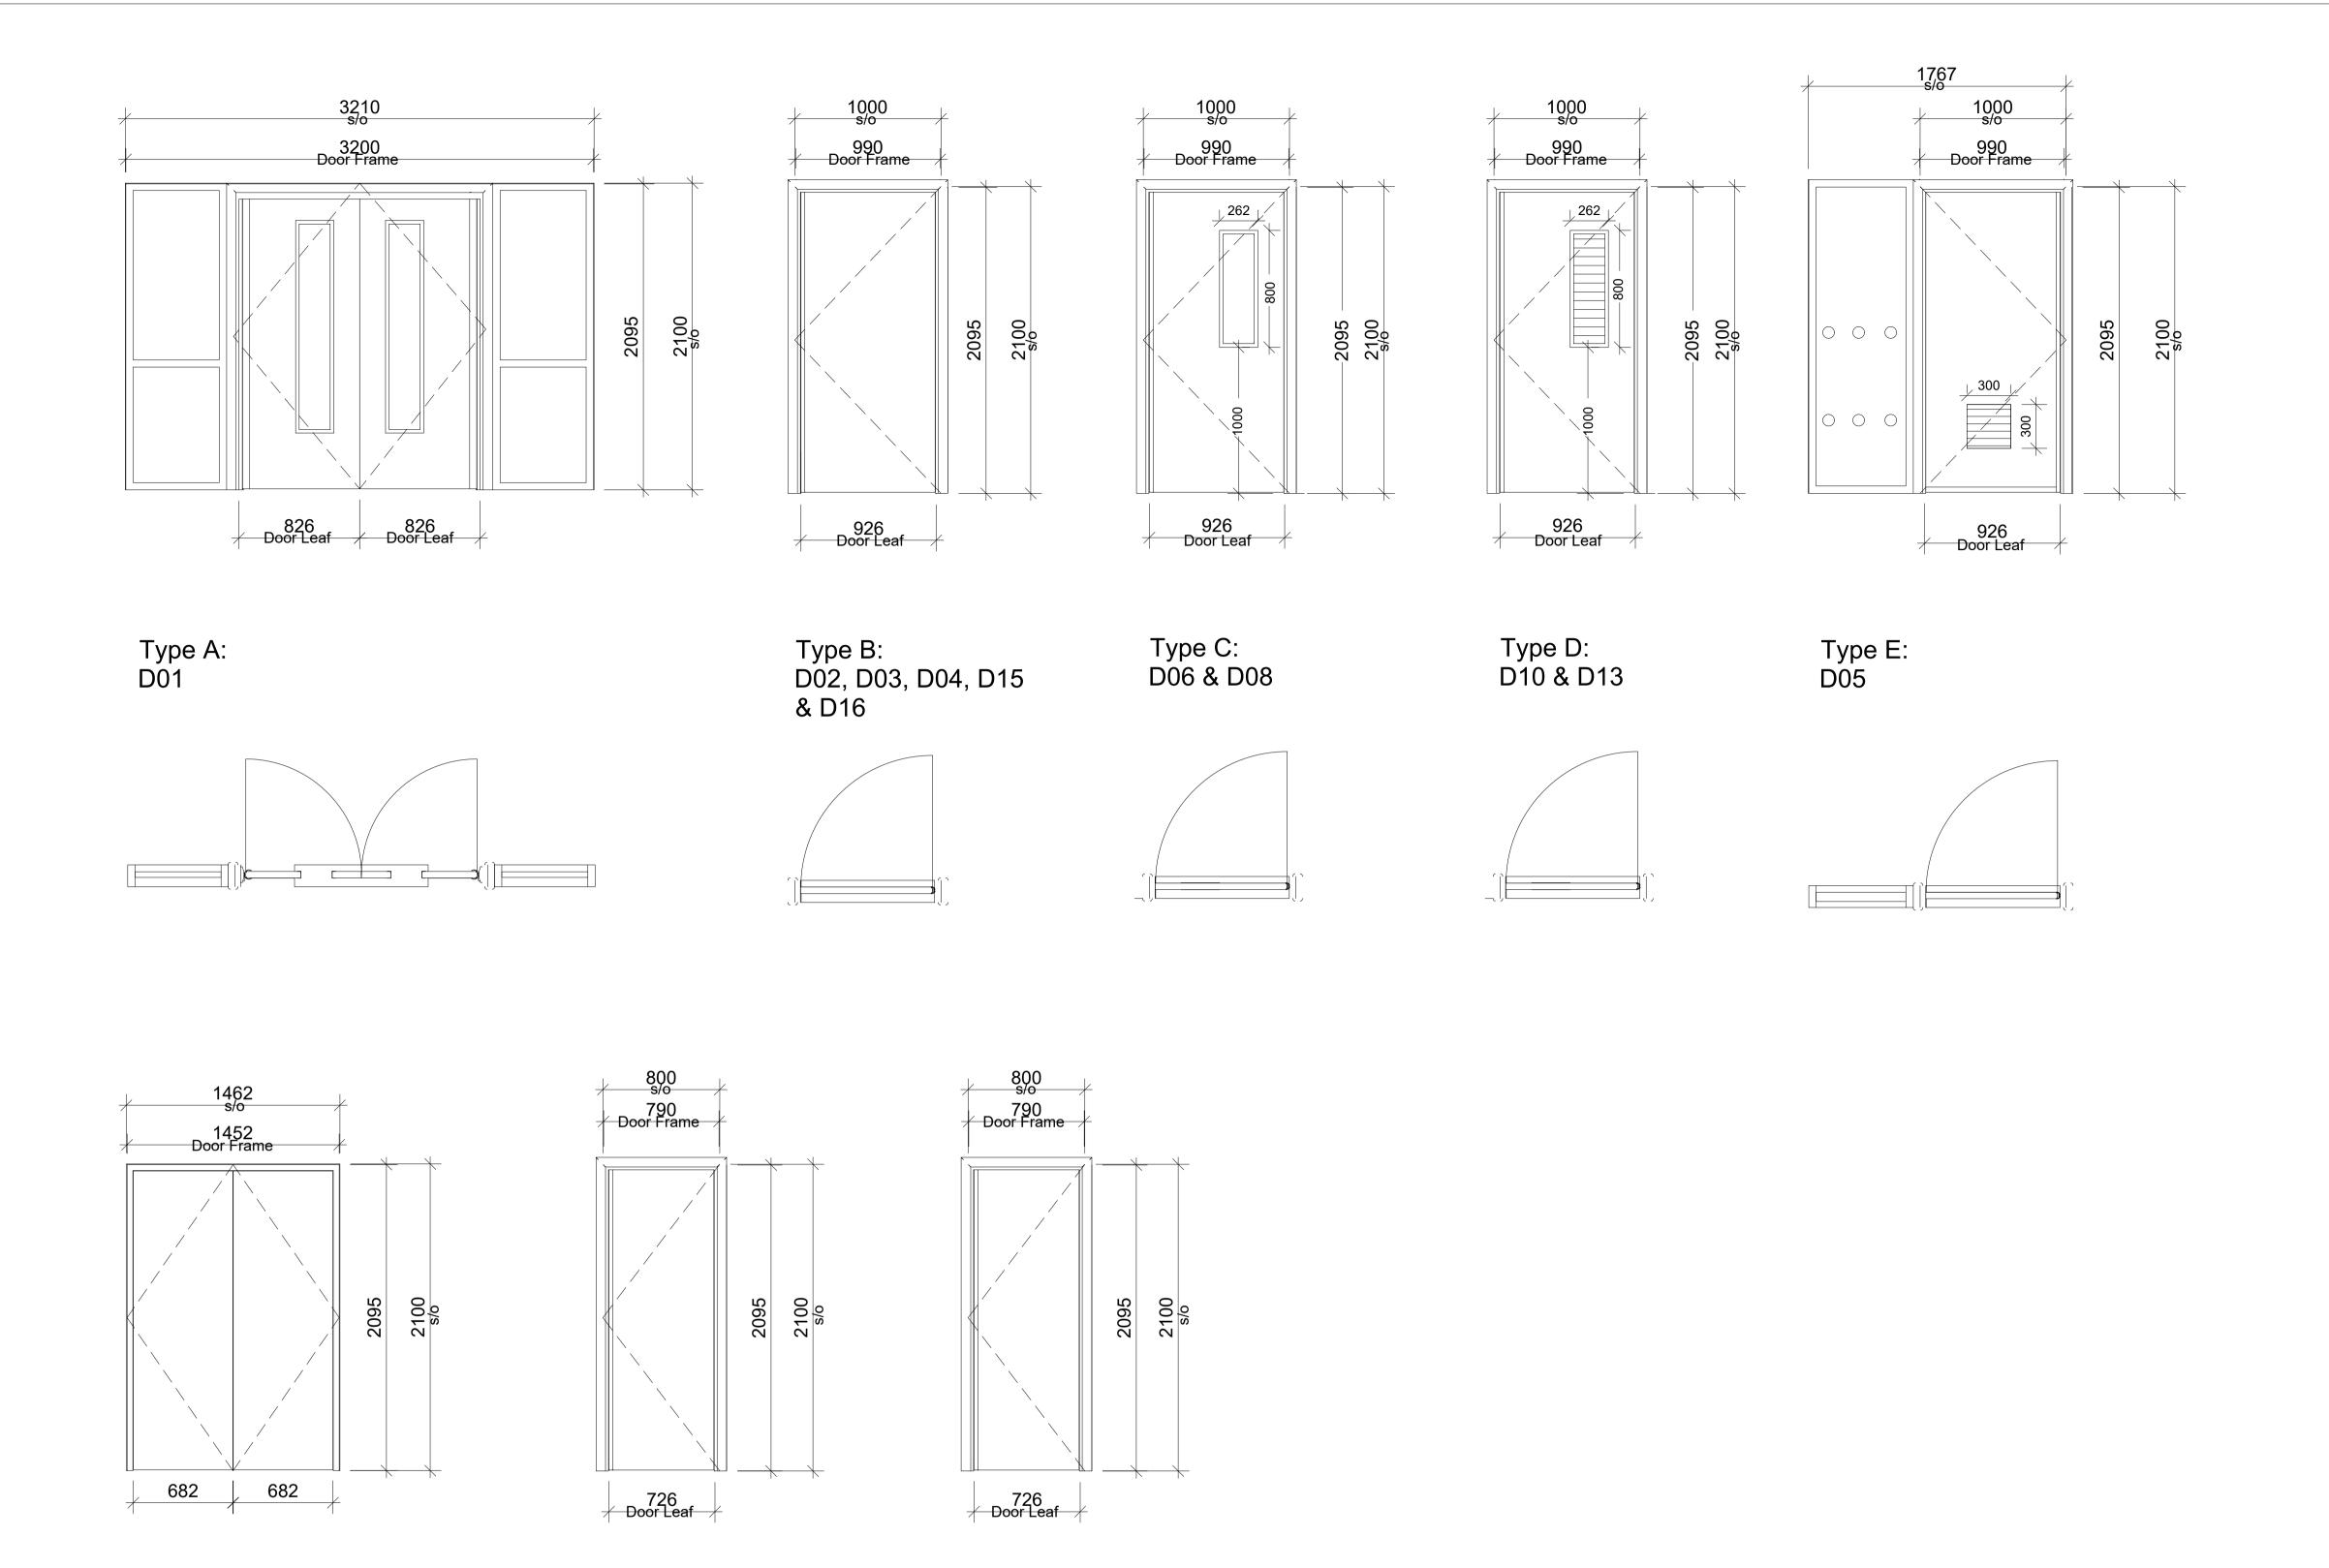
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C(31)02

Northumberland, NE46 4DQ
roject no: Drg No:

1442

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\*REFER TO INTERNAL DOOR SCHEDULE- 1442 (S01) External and Internal Door Schedule\*

Type G:

D11, D12 & D14

Type F: D09 & D17

\*\*\*Male & Female W.C's, Cleaners Store and Accessible W.C doors to be undercut (up to 25mm) to allow for ventilation. Refer for Proposed floor plan drawing No. L(-2)101 for door locations \*\*\*

Type H: D07

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05.02.19 TENDER ISSUE Rev. Date Detail

PROJECT:

## **Shotton Community** Centre

DRAWING TITLE:

## Proposed internal door drawing

CLIENT:

## **Shotton Parish Council**


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Design: MD	RVT: EMN
Chk'd by: MD	App'd: CJW
Date: Jan 19	Scale: 1:50 (@ A3)



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C(32)01



F4 - CFS Illusion Carpet tiles 500x500 - Colour TBC

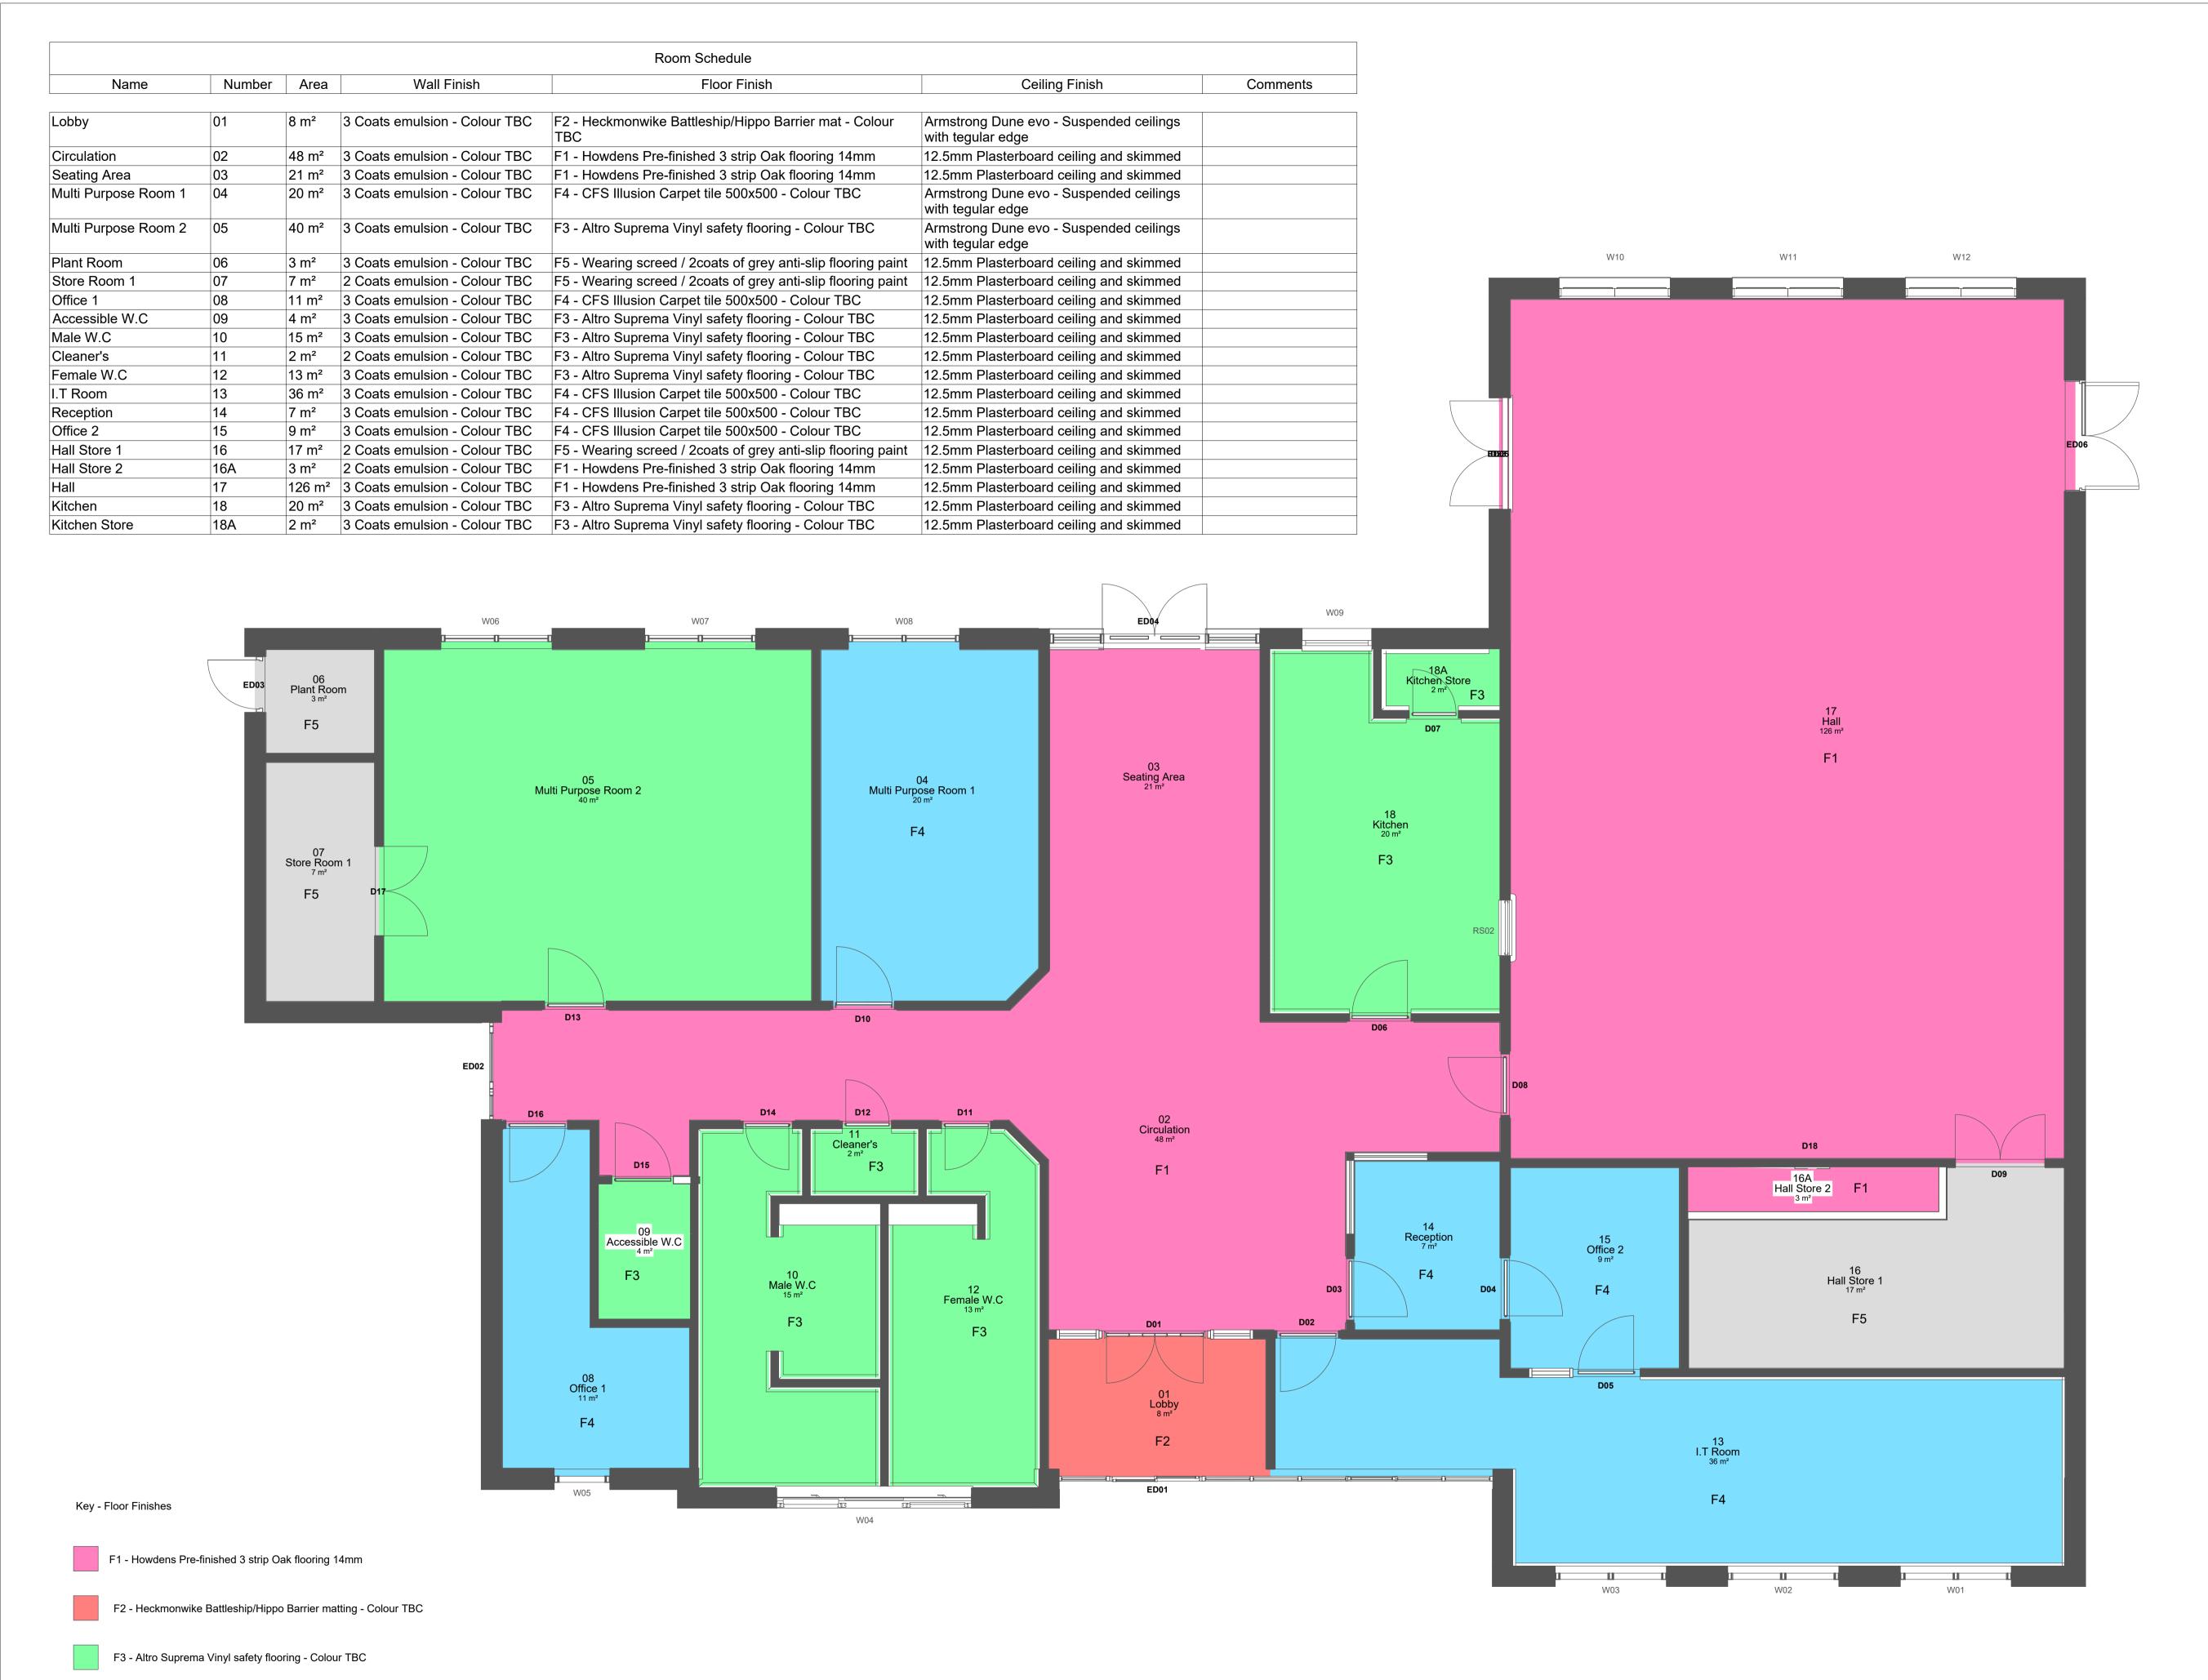F5 - Wearing screed / 2 coats of grey anti-slip flooring paint

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1. ALL DIMENSIONS IN MILLIMETRES (mm) UNLESS

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## Centre

DRAWING TITLE:

## Finishes

### **Shotton Parish** Council


STATUS: TENDER Design: MD RVT: EMN App'd: CJW Chk'd by: CJW Scale: 1:50 (@ A1) Date: Jan 19



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Project no: Drg no: Rev: 1442 L(-2)101



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Mallan House,

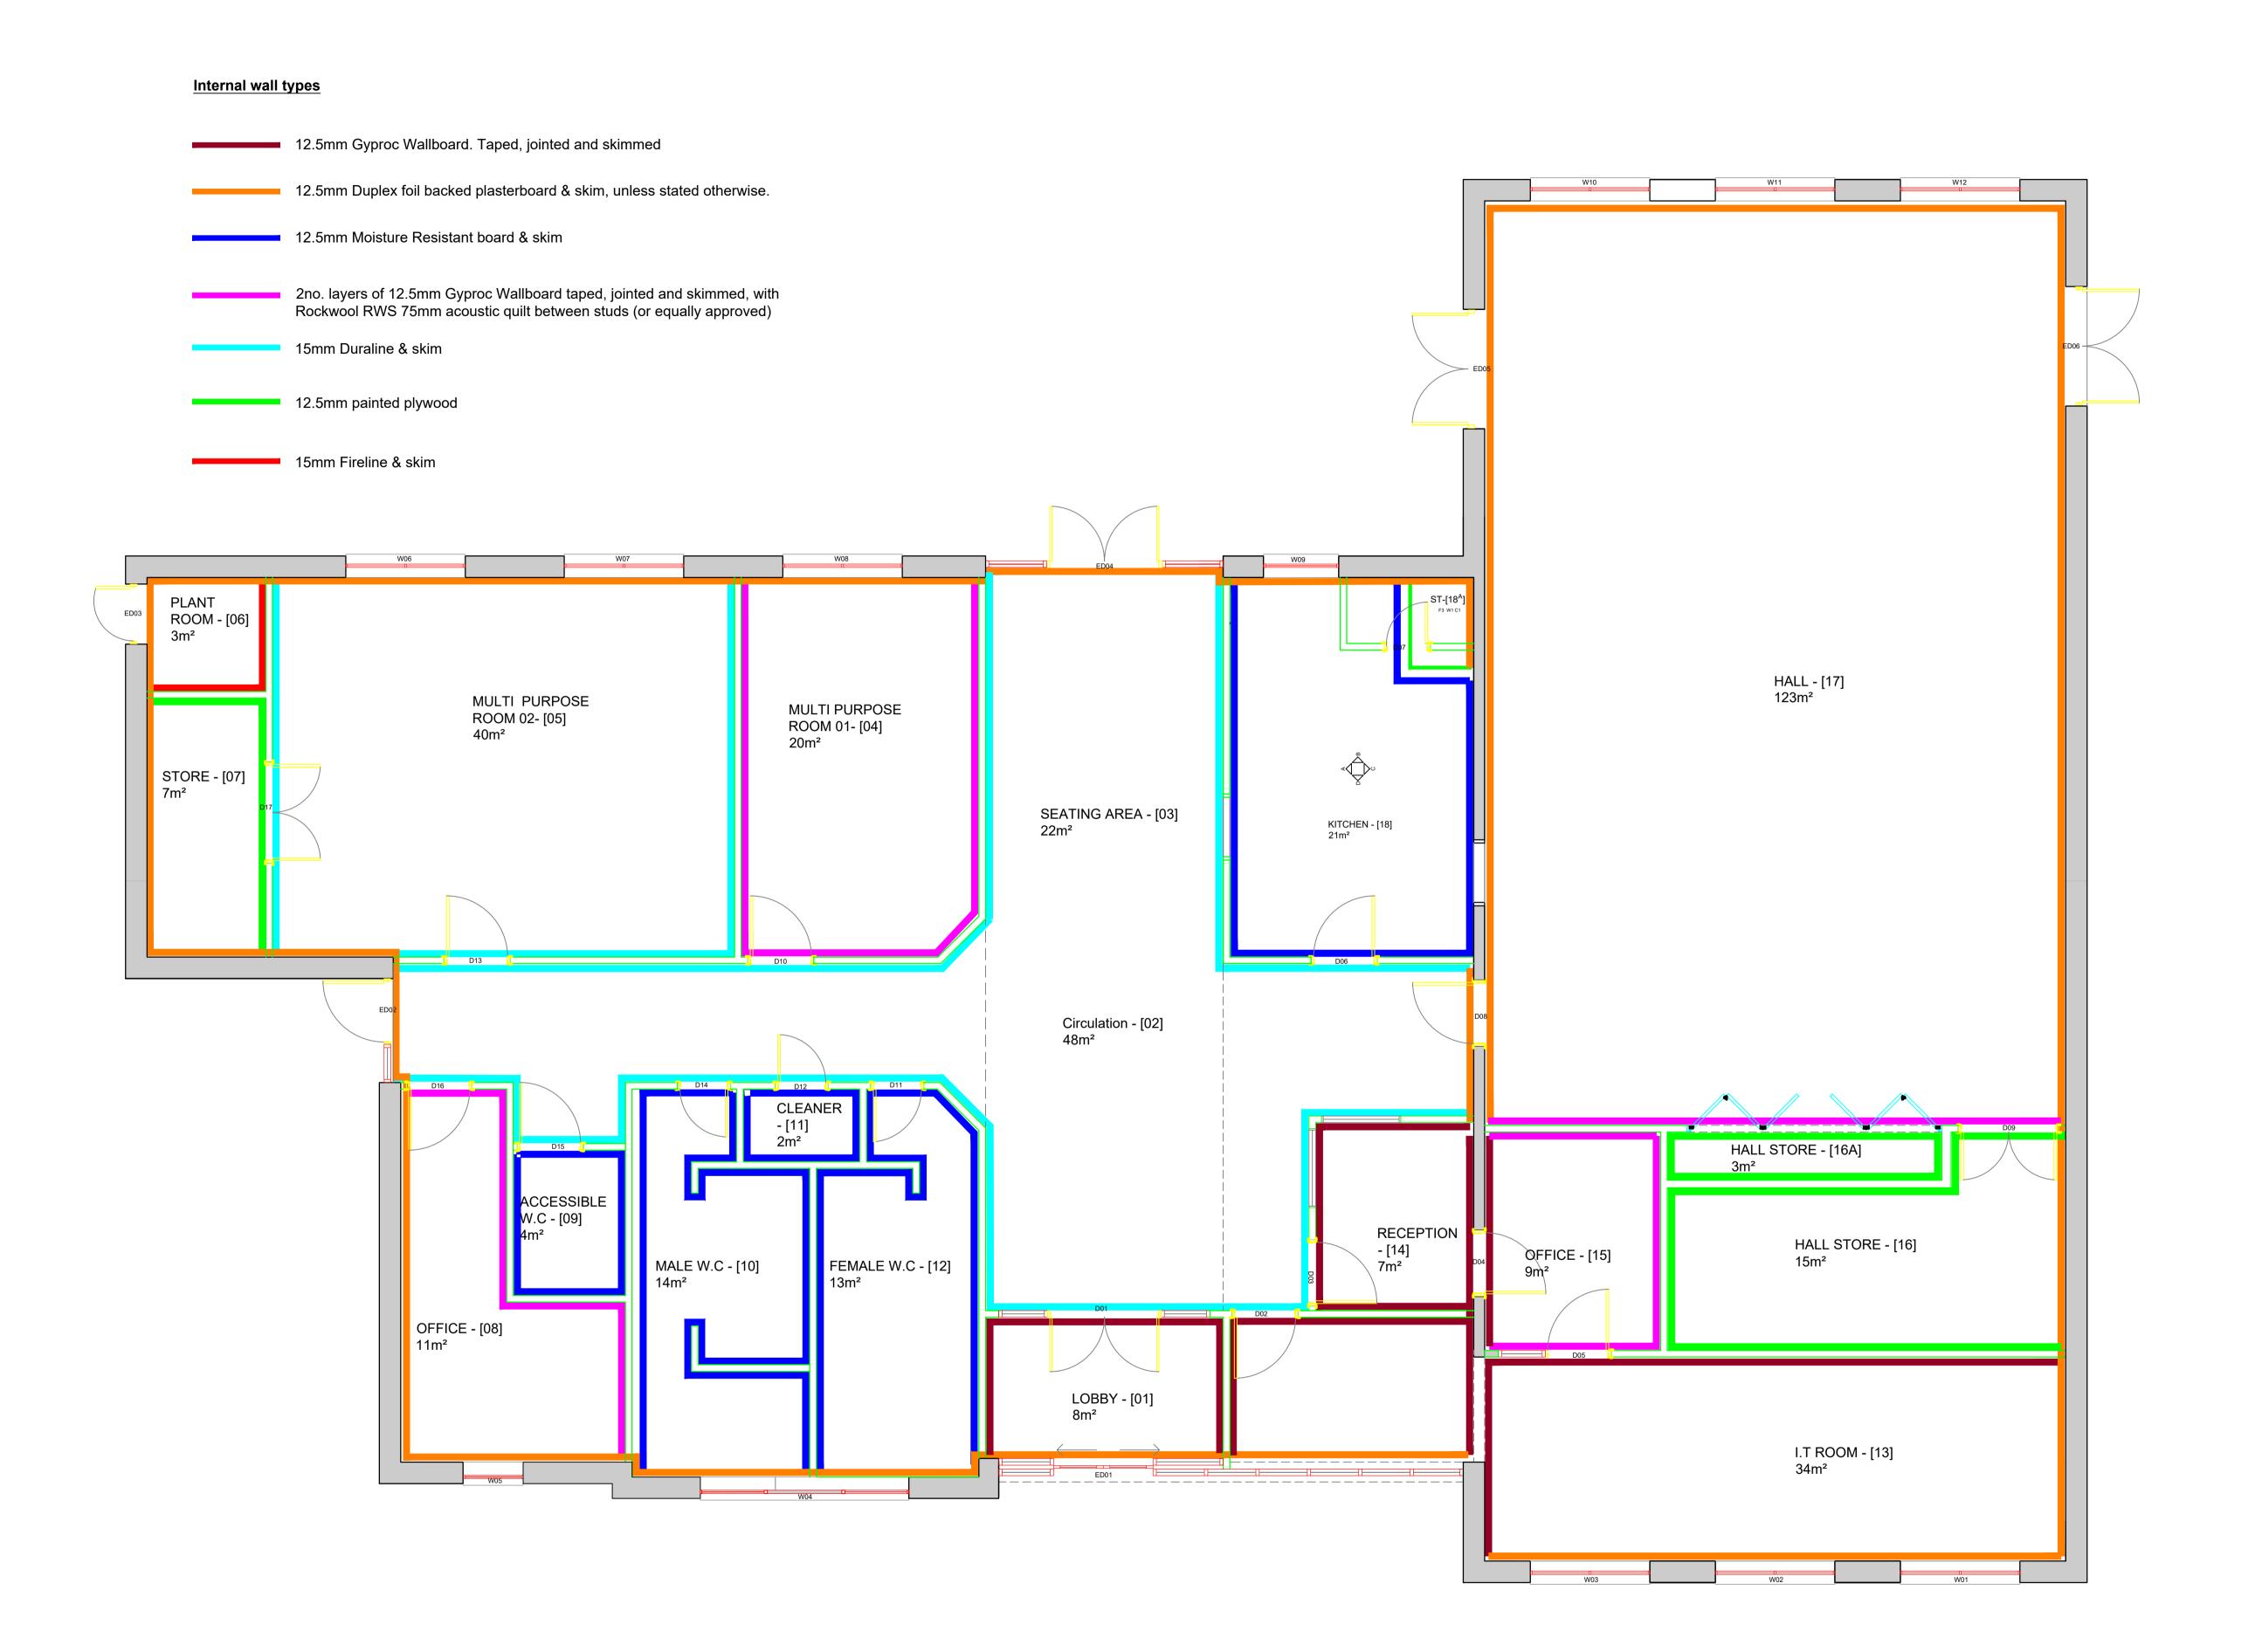1442

Project no:


Bridge End, Hexham,

Northumberland, NE46 4DQ

Drg no:

L(-2)102

NOTES.

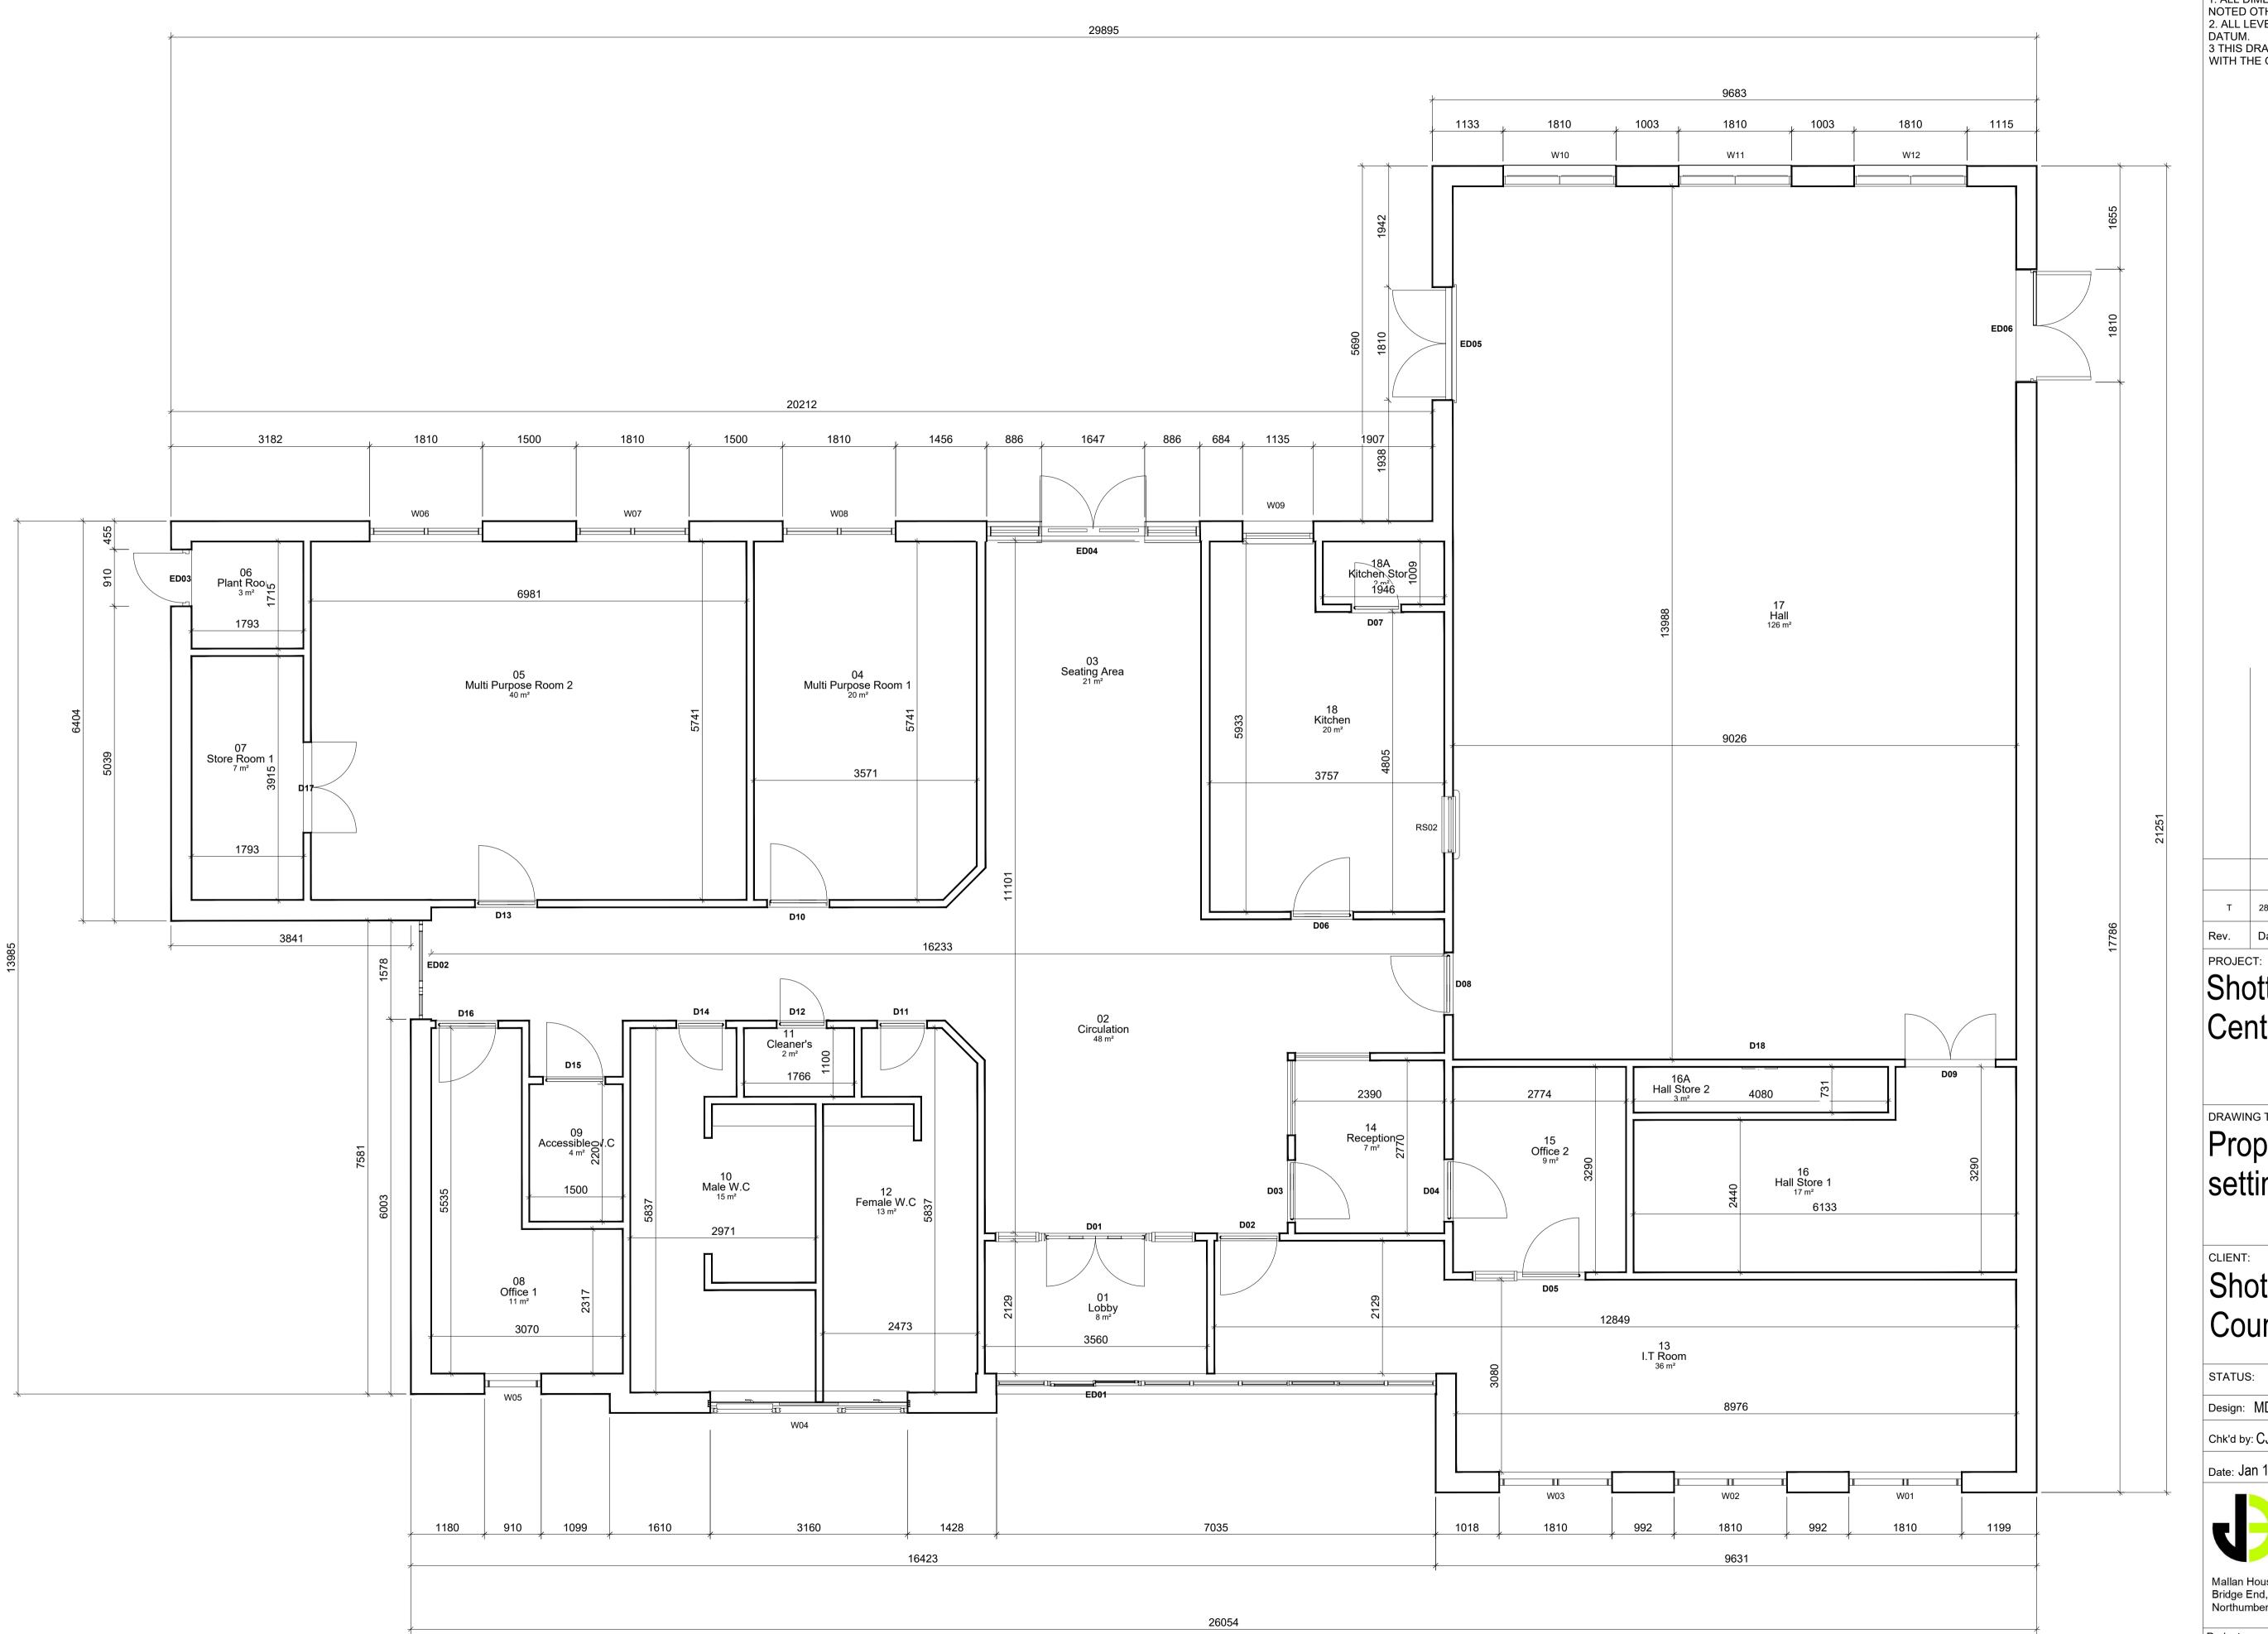

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> T 28.01.19 TENDER ISSUE CJW App'd Detail

**Shotton Community** Centre

DRAWING TITLE:

Proposed Floor plan setting out

**Shotton Parish** Council

STATUS: TENDER RVT: EMN App'd: CJW


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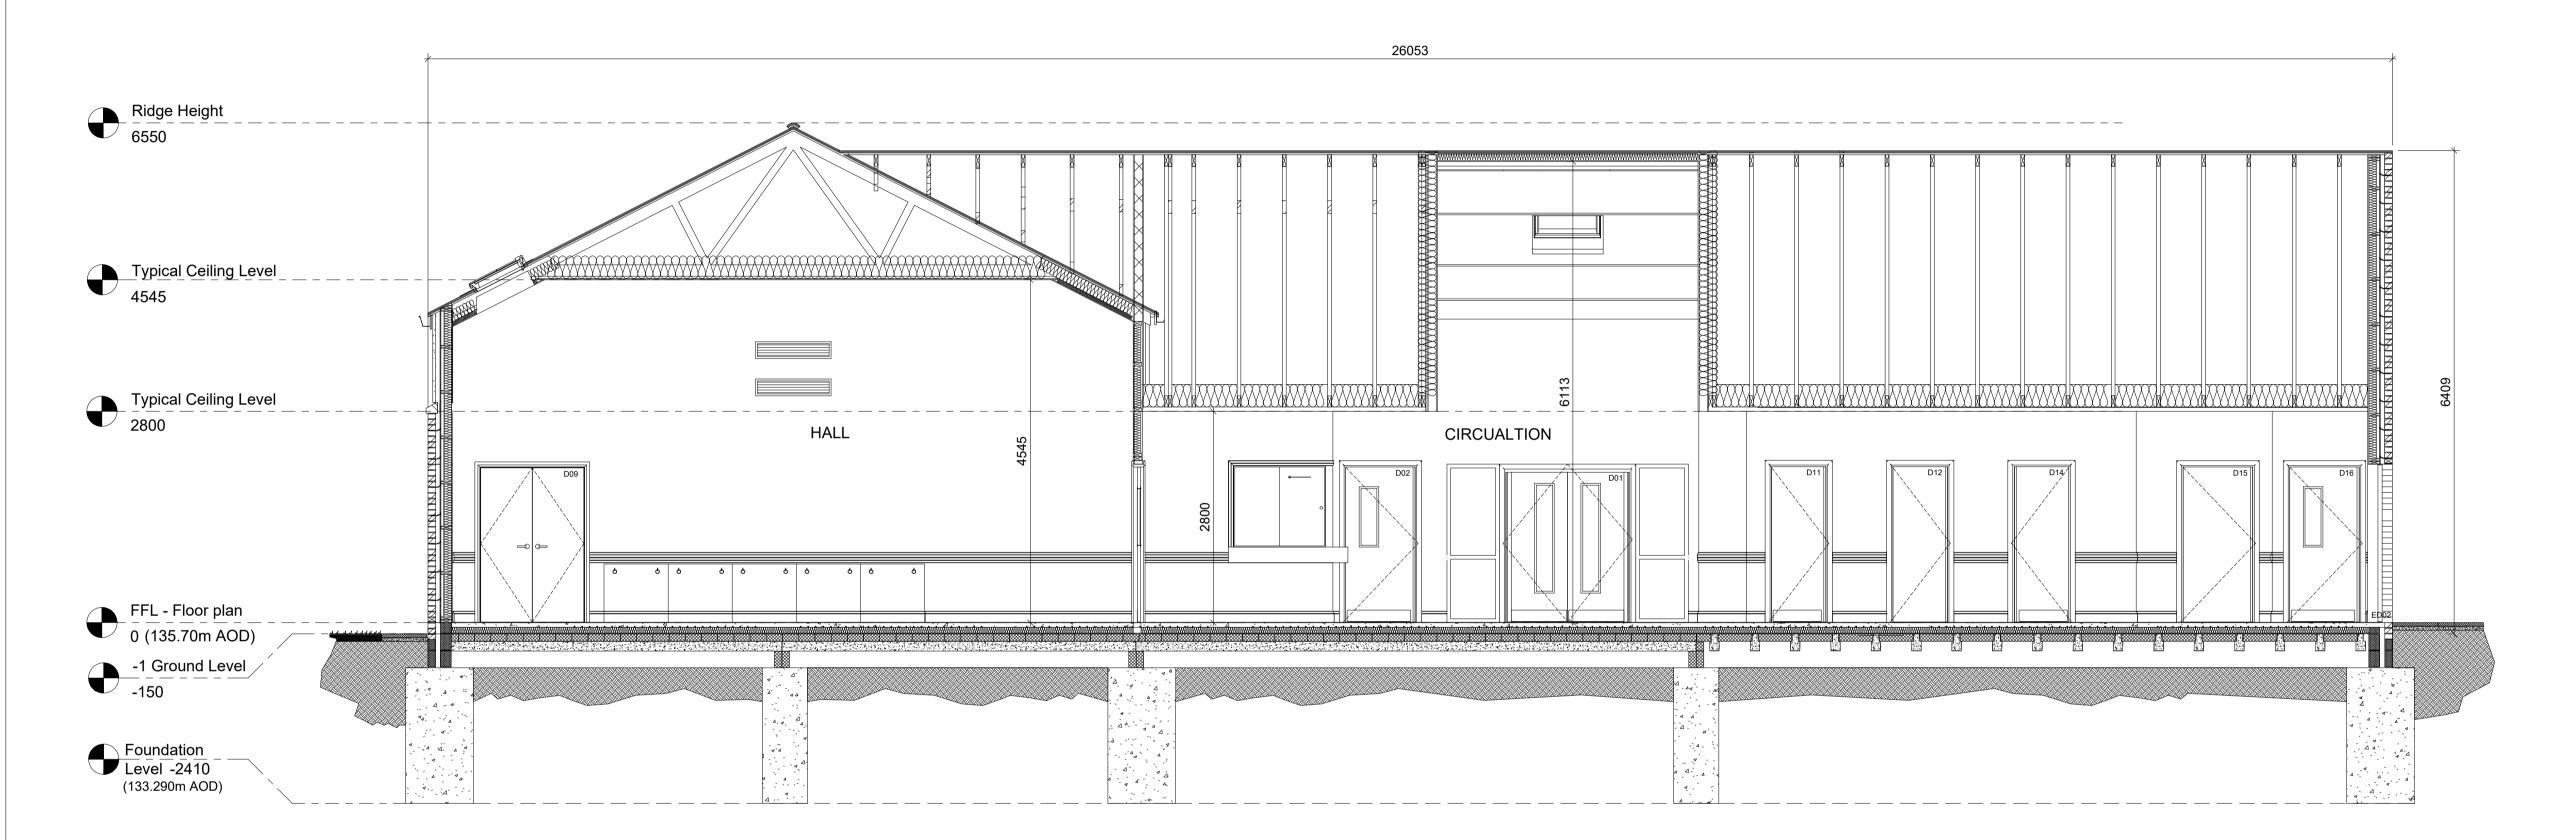


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Drg no: Rev: 1442 L(-2)102 Т





### **SECTION A-A**
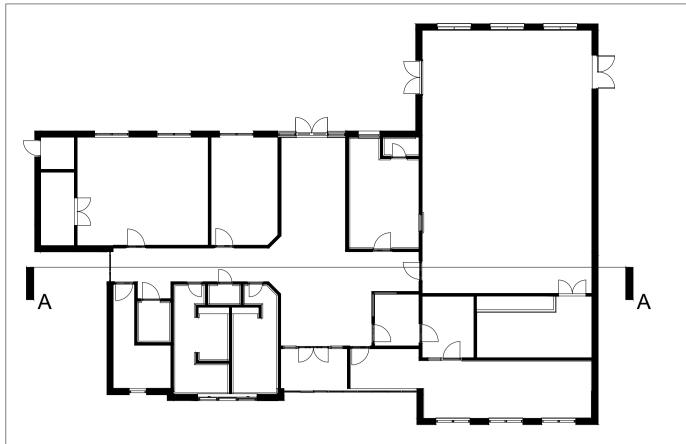
#### Foundations, Sub-Structures & Ground Floor Slab

Foundations to be trenchfill 1800mm deep x 900mm wide for loadbearing walls and 1800mm x 600mm wide for internal walls as drawing no. Concrete to be RC35 with minimum cement content 320kg/m3 with w/c ratio 0.5.

Blockwork dwarf walls on the trenchfill support block and beam floor, layout as drawing. Main Hall to be hanson TJ1 with T008 beams, Remainder of building to be Hanson TJ3 with T008 beams.

Voids below block & beam floor to be ventilated with Rytons Periscope Underfloor Ventilators with Rytons Multifix Air Bricks, or similar approved. Colour to match brickwork, at maximum 2.000m centres to perimeter. Internal block dwarf walls tohave regular voids to allow cross ventilation.

Construct 140mm high blockwork under timber frame wall plates, either 140mm or 90mm wide.

#### **Timber Frame**

Timber framing for external walls, gables & the internal Hall wall to be 140x38 C16 CLS timbers. Internal non-loadbearing walls to be 38x89 C16 CLS timbers. External wall to have 9mm OSB 3 board with reflective breather membrane.

Over Circulation trimming rafters for 2no. Velux Rooflights, PK06, 940x1180mm.

3no. CK02 Velux Rooflights in Hall roof fit between trusses, 550x780mm.

Roof construction is a combination of trussed rafters, and specialist trusses over the Hall (17). Lobby (01), Circulation areas (02) & (03) to be sw rafters on exposed purlins as shown on drawings.

Supply & fit floor joists over rooms 13, 15 & 16 to be 150mm x 50mm @ 400mm centres, with 1800mm x 1800mm decking adjacent to hatch & fan to be 12mm plywood.

#### **Roof Finish**

Marley Eternit Birkdale fibre cement slates, blue black, on 50x32 treated battens on breatheable membrane on 150x50 sw rafters at 600 centres or truss at 600 centres Marley dry ridge, valleys & verges

Allow for trimming rafters & ceiling joists for rooflights & hatches.

Warm roof over Seating Area (03), Circulation (02) & Lobby (01) to have 100 Kingspan Insulation between 150x50 rafters, with 32.5mm insulated plasterboard to soffit & purlins exposed.

Hall 01, Office 07, Store 02 & IT Room 03 to have warm roof from eaves up to horizontal tie beam. Above tie beam lay 300mm insulation quilt on 12mm plasterboard. Vertical sections of wall panels to be insulated to maintain warm roof. Cold roofs in remaining trussed rafter areas to have 300mm quilt insulation & ventilated eaves.

Black uPVC Deep Flow gutters and downpipes on marine grade fascia & soffit, painted black. 2no vent tiles over Kitchen flow extracts.

#### **External Walls**

Facing bricks to be Ibstock Smooth Buff and Ibstock Brunswick Tryfan Grey A0642A with light bucket handle joint in natural mortarExternal brickwork walls to be banded as shown on elevations.Bricks laid stretcher bond and tied back to timber frame with Ancon Staifix STF6 ties, 127mm long fixed with 4x30mm stainless steel spax screws.Timber Frame lintols over external windows & doors to be pre-galvanised mild steel, powdercoated black, Catnic CTF5 or equal approved.

On the Hall 01 use I.C. 1.1 Overhanging Angled Sill bricks as soldier course between the brickwork & Coloured Render.

Bricks 140mm high, 152mm deep (with 25mm overhang to front) and 65mm wide. Joints to be flush pointed. Also at external corners use IC5 Overhanging Angled Sill External Return.

At all door & window openings in external walls, fit 50mm Kingspan Thermabate Cavity Closers.

CBS cavity wall weep vents at 900 centres in wall at floor level & 450 centres over lintols (minimum 2 per lintol). Allow for 2no. vertical movement joints in brickwork as shown on elevations.

Coloured render at high level in Hall external walls to be 5mm render in 2 coats over glass fibre mesh on 12mm carrier board on 80x35mm horizontal treated sw battens on 25x25 vertical treated sw battens with ventilation cavity, to be K Rend Scraped Texture or equal approved. Form openings for 4no extract grills as detailed in Mechanical

Services Builders Work Schedule.

#### Aluminium Windows & External Doors

External doors as Drawing C(31)01 & Schedule S01.
Aluminium double glazed windows as Drawing C(31)02 & Schedule S02.3no. rooflights over Hall to be Velux CK02, 550x780mm, Integra electronically operated, with integral blinds & automatic rain sensors. White polyurethane internal finish & standard laminated safety glass.

2no. rooflights over Seated Area to be Velux PK06, 940x1180mm, as item 7.3.Allow for insulated aluminium panels to match as shown Include for manifestations to low level glazing as shown.

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# Shotton Community Centre

DRAWING TITLE:

## Proposed Section A-A

CLIENT:

# Shotton Parish Council

STATUS: TENDER

Design: MD RVT: EMN

Chk'd by: MD App'd: MD

Date: Sep 18 Scale: (@ A1)



Mallan House,

Bridge End, Hexham,

Northumberland, NE46 4DQ

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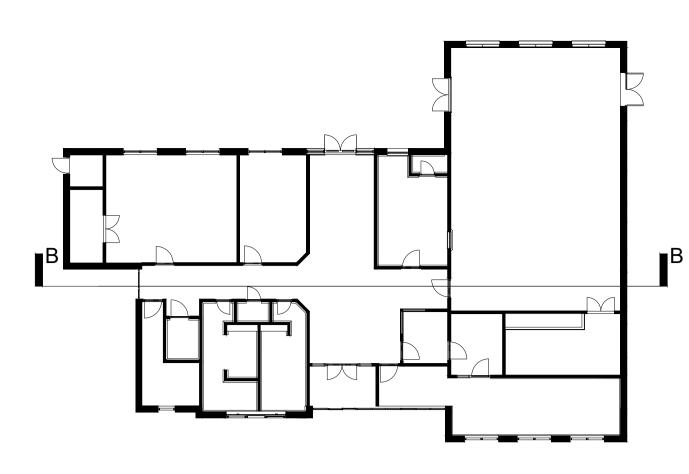
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Project no: Drg no: Rev:

1442 L(-3)101 T



**SECTION B-B** 

#### Foundations, Sub-Structures & Ground Floor Slab

Foundations to be trenchfill 1800mm deep x 900mm wide for loadbearing walls and 1800mm x 600mm wide for internal walls as drawing no. Concrete to be RC35 with minimum cement content 320kg/m3 with w/c ratio 0.5.

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Allow for trimming rafters & ceiling joists for rooflights &

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NOTES.

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panels to match as shown Include for manifestations to low level glazing as shown. Ironmongery to external doors to match internal

> 05.02.19 TENDER ISSUE CJW Date App'd

**Shotton Community** Centre

DRAWING TITLE:

Proposed Section B-B

## **Shotton Parish** Council

STATUS: TENDER

Design: MD RVT: EMN App'd: CJW Chk'd by: CJW Date: Jan 19 Scale: 1:50 (@ A1)





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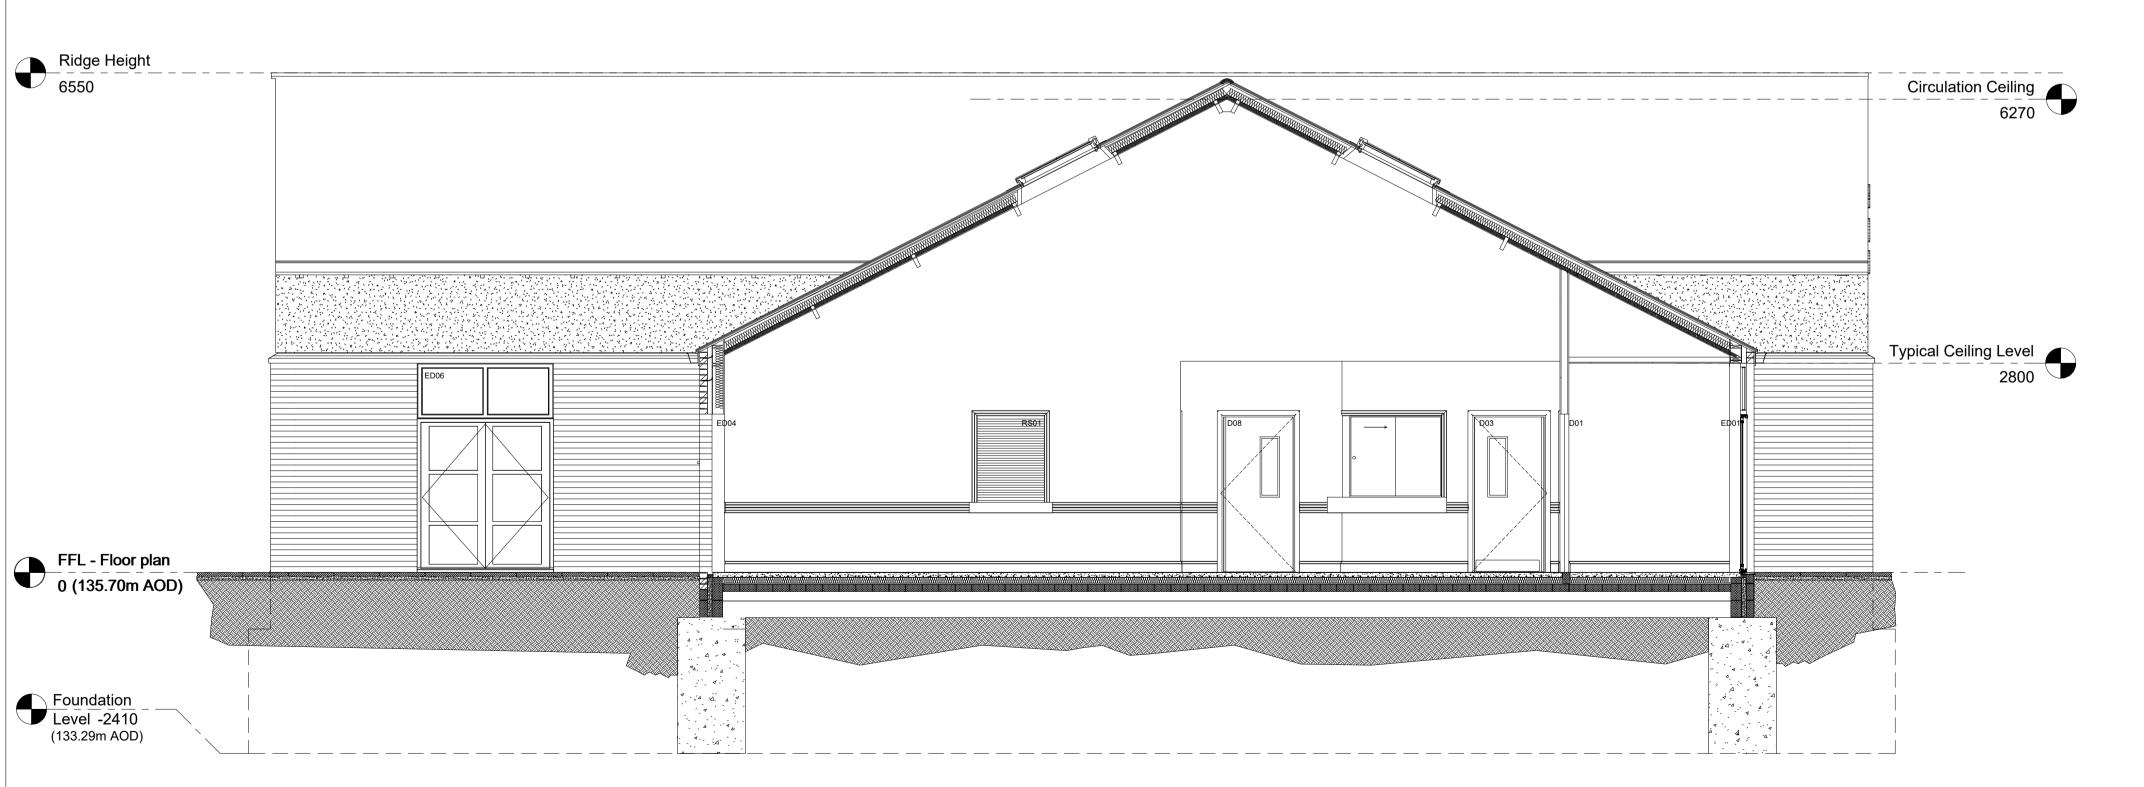
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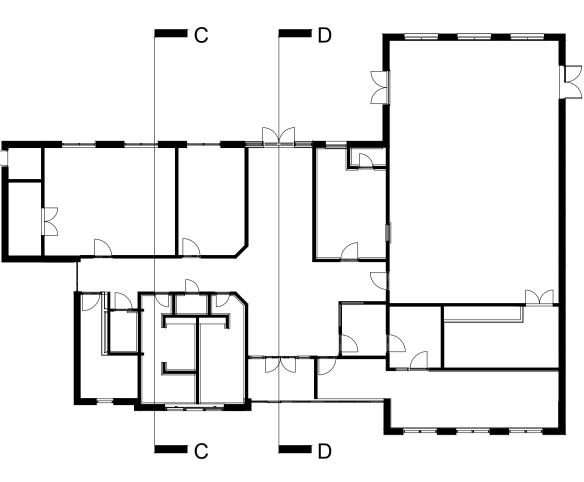
Project no: Drg no: 1442 L(-3)102





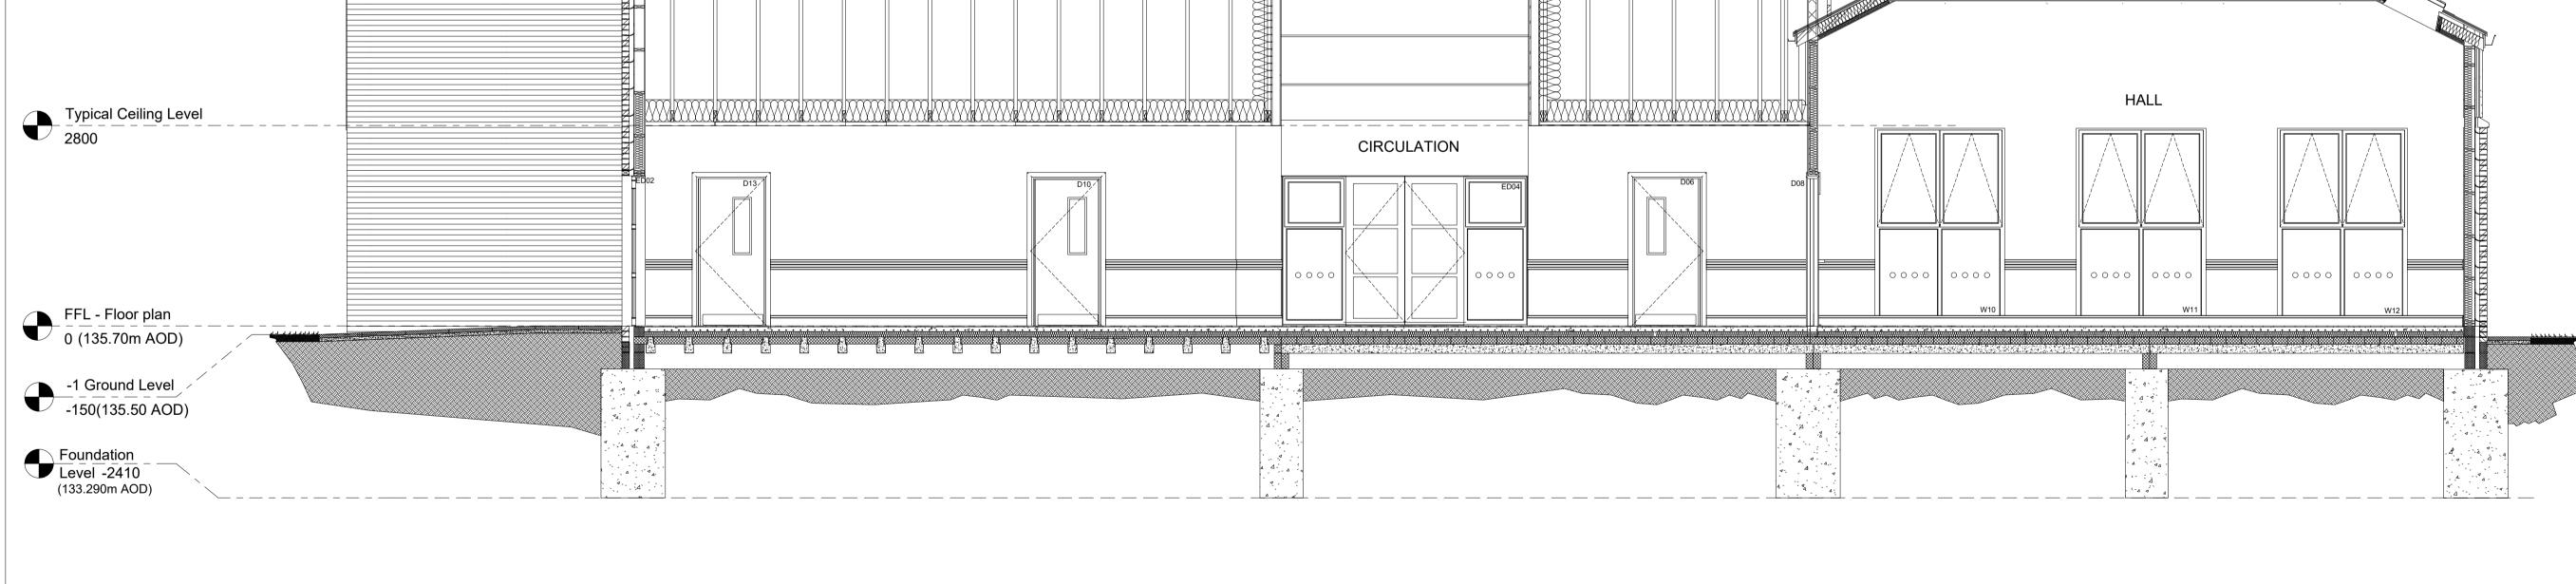

SECTION D-D

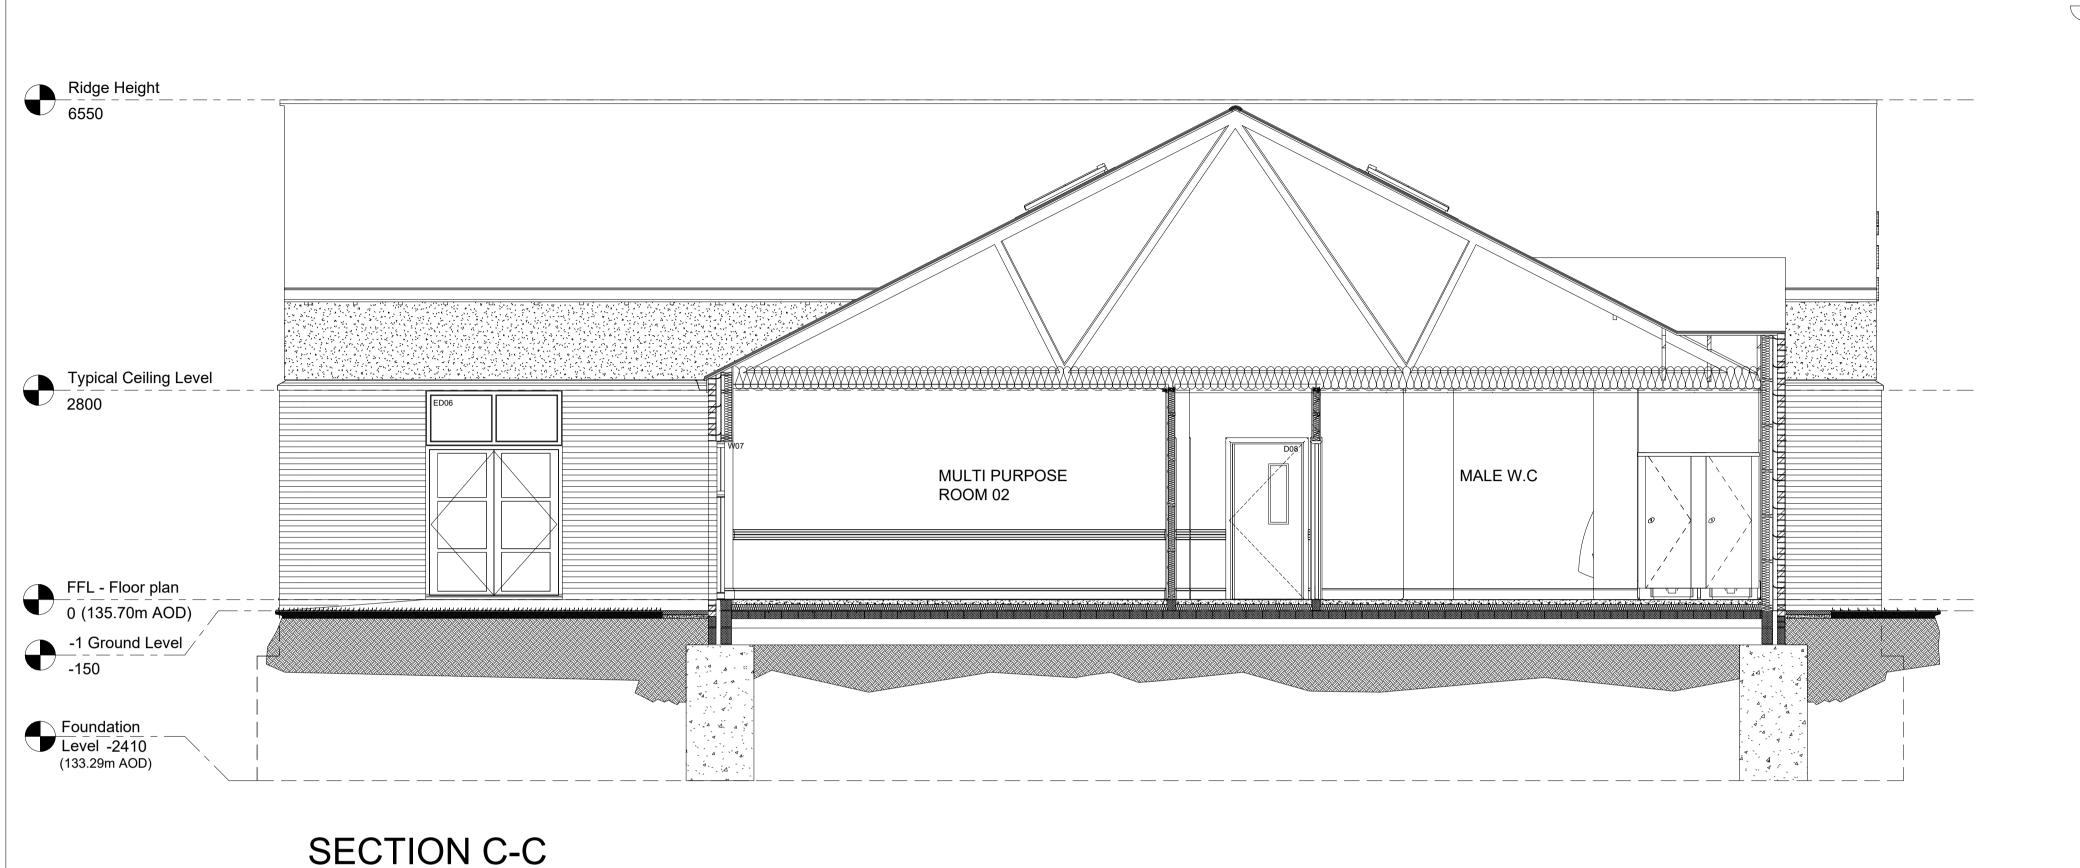

#### Foundations, Sub-Structures & Ground Floor Slab

Foundations to be trenchfill 1800mm deep x 900mm wide for loadbearing walls and 1800mm x 600mm wide for internal walls as drawing no. Concrete to be RC35 with minimum cement content 320kg/m3 with w/c ratio 0.5.

Blockwork dwarf walls on the trenchfill support block and beam floor, layout as drawing . Main Hall to be hanson TJ1 with T008 beams, Remainder of building to be Hanson TJ3 with T008 beams.

Voids below block & beam floor to be ventilated with Rytons Periscope Underfloor Ventilators with Rytons Multifix Air Bricks, or similar approved. Colour to match brickwork, at maximum 2.000m centres to perimeter. Internal block dwarf walls tohave regular voids to allow cross ventilation.

Construct 140mm high blockwork under timber frame wall plates, either 140mm or 90mm wide.

#### **Timber Frame**

Timber framing for external walls, gables & the internal Hall wall to be 140x38 C16 CLS timbers. Internal non-loadbearing walls to be 38x89 C16 CLS timbers. External wall to have 9mm OSB 3 board with reflective breather membrane.

Over Circulation trimming rafters for 2no. Velux Rooflights, PK06,

3no. CK02 Velux Rooflights in Hall roof fit between trusses, 550x780mm.

Roof construction is a combination of trussed rafters, and specialist trusses over the Hall (17). Lobby (01), Circulation areas (02) & (03) to be sw rafters on exposed purlins as shown on drawings.

Supply & fit floor joists over rooms 13, 15 & 16 to be 150mm x 50mm @ 400mm centres, with 1800mm x 1800mm decking adjacent to hatch & fan to be 12mm plywood.

#### **Roof Finish**

Marley Eternit Birkdale fibre cement slates, blue black, on 50x32 treated battens on breatheable membrane on 150x50 sw rafters at 600 centres or truss at 600 centres

Marley dry ridge, valleys & verges

Allow for trimming rafters & ceiling joists for rooflights & hatches. Warm roof over Seating Area (03), Circulation (02) & Lobby (01) to have 100 Kingspan Insulation between 150x50 rafters, with 32.5mm insulated

plasterboard to soffit & purlins exposed. Hall 01, Office 07, Store 02 & IT Room 03 to have warm roof from eaves up to horizontal tie beam. Above tie beam lay 300mm insulation quilt on 12mm plasterboard. Vertical sections of wall panels to be insulated to maintain warm roof.

Cold roofs in remaining trussed rafter areas to have 300mm quilt insulation & ventilated eaves.

Black uPVC Deep Flow gutters and downpipes on marine grade fascia &

soffit, painted black. 2no vent tiles over Kitchen flow extracts.

#### **External Walls**

Facing bricks to be Ibstock Smooth Buff and Ibstock Brunswick Tryfan Grey A0642A with light bucket handle joint in natural mortarExternal brickwork walls to be banded as shown on elevations. Bricks laid stretcher bond and tied back to timber frame with Ancon Staifix STF6 ties, 127mm long fixed with 4x30mm stainless steel spax screws. Timber Frame lintols over external windows & doors to be pre-galvanised mild steel, powdercoated black, Catnic CTF5 or equal approved.

On the Hall 01 use I.C. 1.1 Overhanging Angled Sill bricks as soldier course between the brickwork & Coloured Render. Bricks 140mm high, 152mm deep (with 25mm overhang to front) and 65mm wide. Joints to be flush pointed. Also at external corners use IC5 Overhanging Angled Sill External Return.

At all door & window openings in external walls, fit 50mm Kingspan Thermabate Cavity Closers.

CBS cavity wall weep vents at 900 centres in wall at floor level & 450

centres over lintols (minimum 2 per lintol).


Allow for 2no. vertical movement joints in brickwork as shown on

Coloured render at high level in Hall external walls to be 5mm render in 2 coats over glass fibre mesh on 12mm carrier board on 80x35mm horizontal treated sw battens on 25x25 vertical treated sw battens with ventilation cavity, to be K Rend Scraped Texture or equal approved. Form openings for 4no extract grills as detailed in Mechanical Services Builders Work Schedule.

#### **Aluminium Windows & External Doors**

External doors as Drawing C(31)01 & Schedule S01. Aluminium double glazed windows as Drawing C(31)02 & Schedule S02. 3no. rooflights over Hall to be Velux CK02, 550x780mm, Integra electronically operated, with integral blinds & automatic rain sensors. White polyurethane internal finish & standard laminated safety glass. 2no. rooflights over Seated Area to be Velux PK06, 940x1180mm, as item Allow for insulated aluminium panels to match as shown Include for manifestations to low level glazing as shown. Ironmongery to external doors to match internal

1. ALL DIMENSIONS IN MILLIMETRES (mm) UNLESS NOTED OTHERWISE. 2. ALL LEVELS ARE IN METRES (m) ABOVE ORDNANCE 3 THIS DRAWING SHOULD BE READ IN CONJUNCTION WITH THE GENERAL ARRANGEMENT DRAWING.

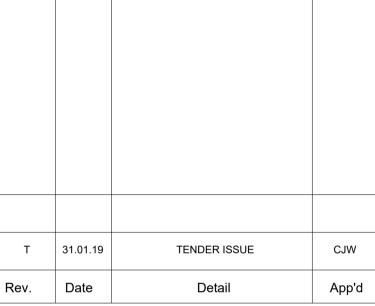

#### PROJECT:

### **Shotton Community** Centre

DRAWING TITLE:

Proposed Section C-C & D-D

## **Shotton Parish** Council

STATUS: TENDER Design: MD RVT: EMN Chk'd by: CJW App'd: CJW

Date: Jan 19 Scale: 1:50 (@ A1)



associates


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info@d3-associates.co.uk

www.d3-associates.co.uk

Mallan House, Bridge End, Hexham, Northumberland, NE46 4DQ

Rev: Project no: Drg no: 1442 L(-3)103

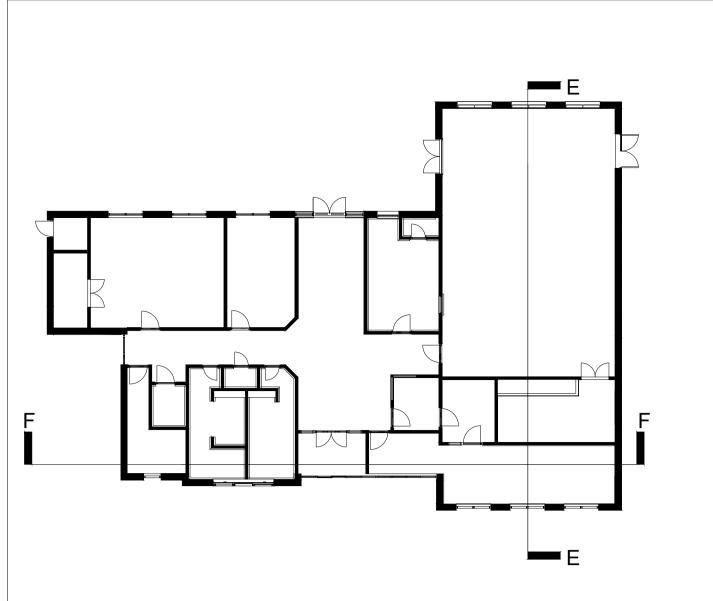

Foundations, Sub-Structures & Ground Floor Slab

Foundations to be trenchfill 1800mm deep x 900mm wide for loadbearing walls and 1800mm x 600mm wide for internal walls as drawing no. Concrete to be RC35 with minimum cement content 320kg/m3 with w/c ratio 0.5.

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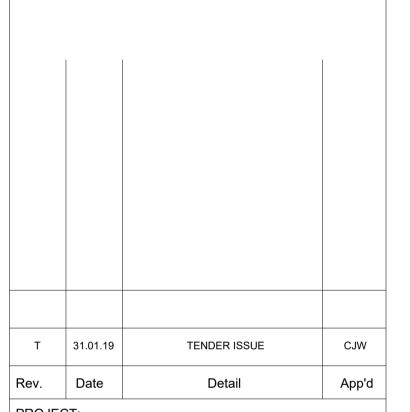
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I.T. ROOM

NOTES. 1. ALL DIMENSIONS IN MILLIMETRES (mm) UNLESS NOTED OTHERWISE. 2. ALL LEVELS ARE IN METRES (m) ABOVE ORDNANCE 3 THIS DRAWING SHOULD BE READ IN CONJUNCTION

WITH THE GENERAL ARRANGEMENT DRAWING.



Centre

Proposed Section E-E & F-F

Shotton Community

**Shotton Parish** Council

STATUS: TENDER

Design: MD	RVT: EMN
Chk'd by: CJW	App'd: CJW
Date: Jan 19	Scale: 1:50 (@ A1)




associates

Bridge End, Hexham, Northumberland, NE46 4DQ

1442

L(-3)103

info@d3-associates.co.uk www.d3-associates.co.uk Rev:

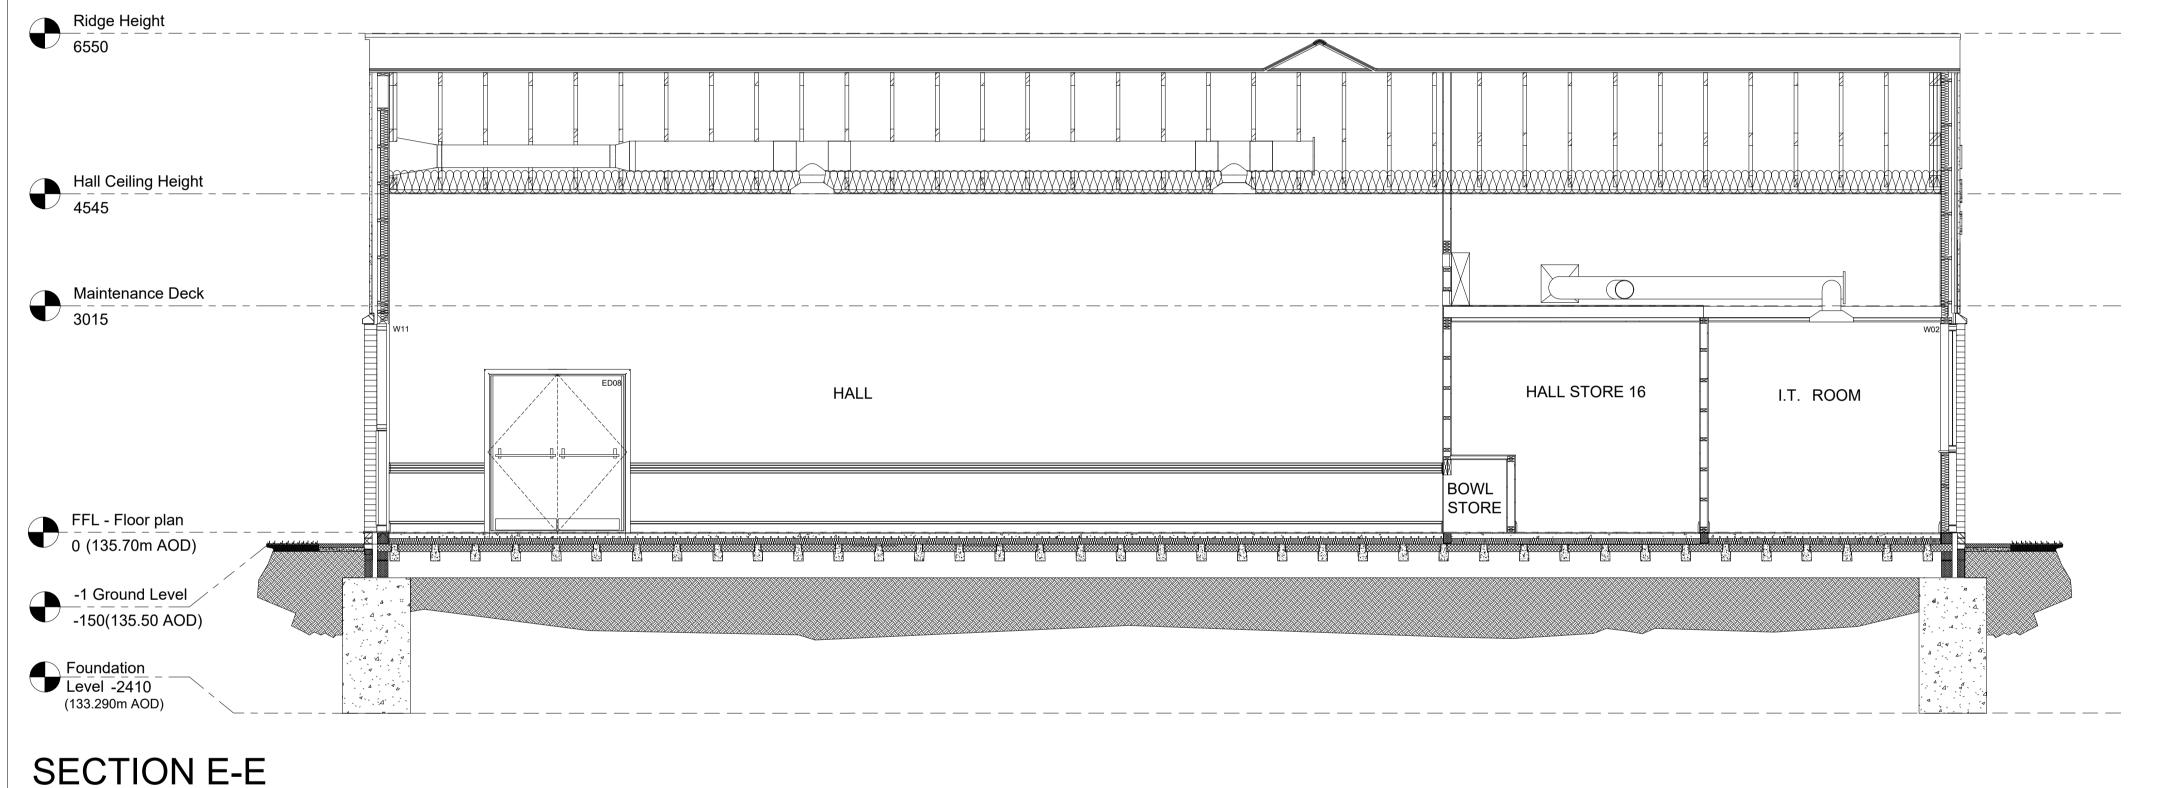

MALE

W.C.

OFFICE

**FEMALE** 


LOBBY

FFL - Floor plan 0 (135.70m AOD)

-1 Ground Level -150(135.50 AOD)

Ridge Height 6240

Typical Ceiling Level 2800

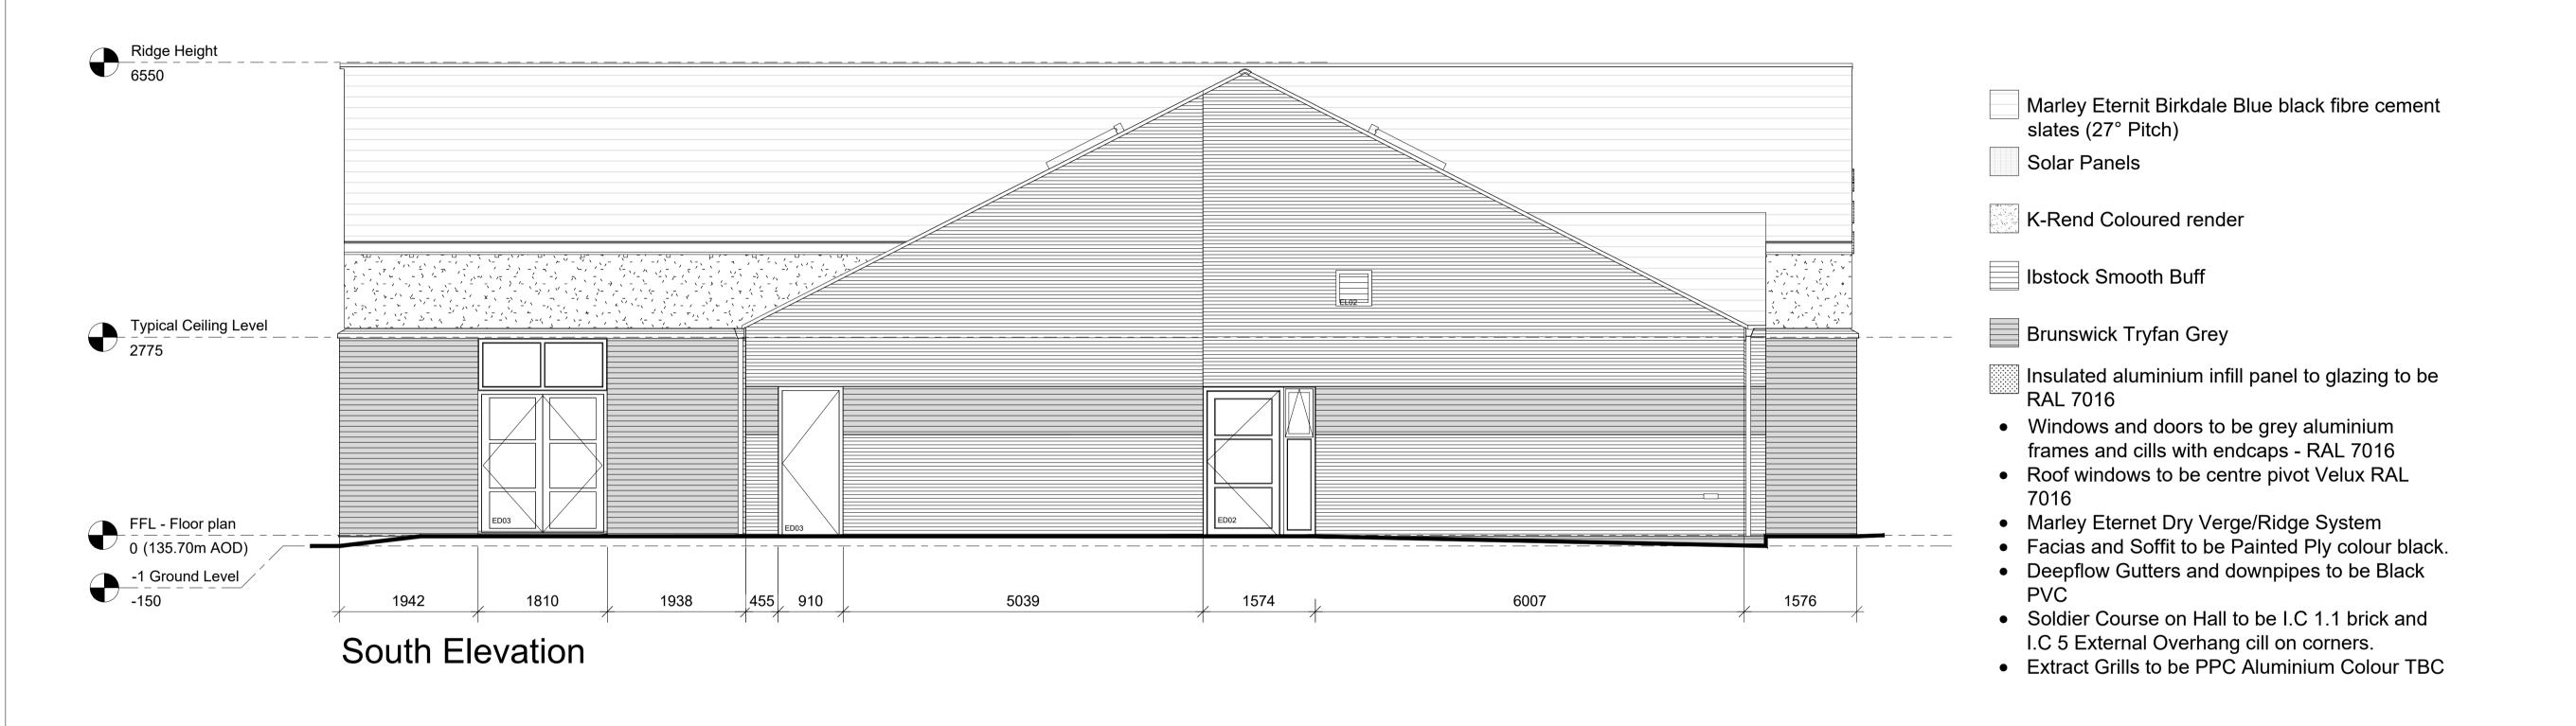



West Elevation

NOTES.

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ORDNANCE DATUM.
3 THIS DRAWING SHOULD BE READ IN
CONJUNCTION WITH THE GENERAL
ARRANGEMENT DRAWING.

Т	05.02.19	TENDER ISSUE	CJW
Rev.	Date	Detail	App'd

PROJECT:

## Shotton Community Centre

Proposed
Elevations Sheet 1

CLIENT:


## Shotton Parish Council

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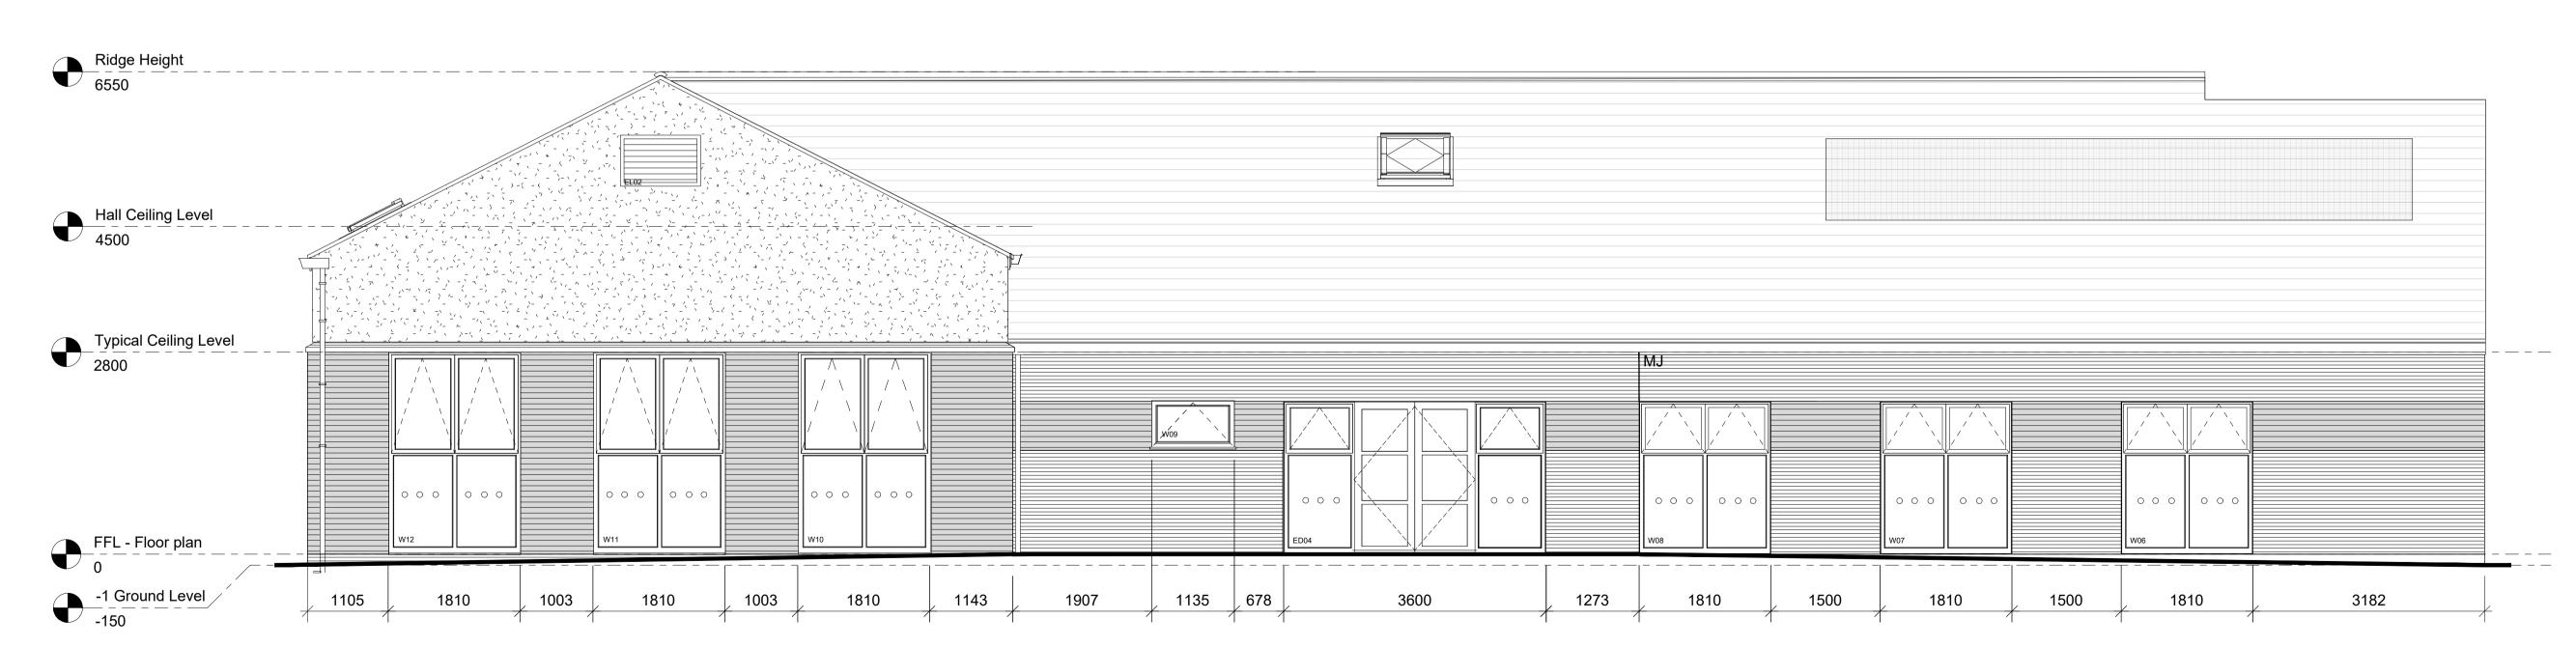


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Bridge End, Hexham, info@d3-associates.co.uk
Northumberland, NE46 4DQ www.d3-associates.co.uk

Project no: Drg No: 1442 L(-4)101

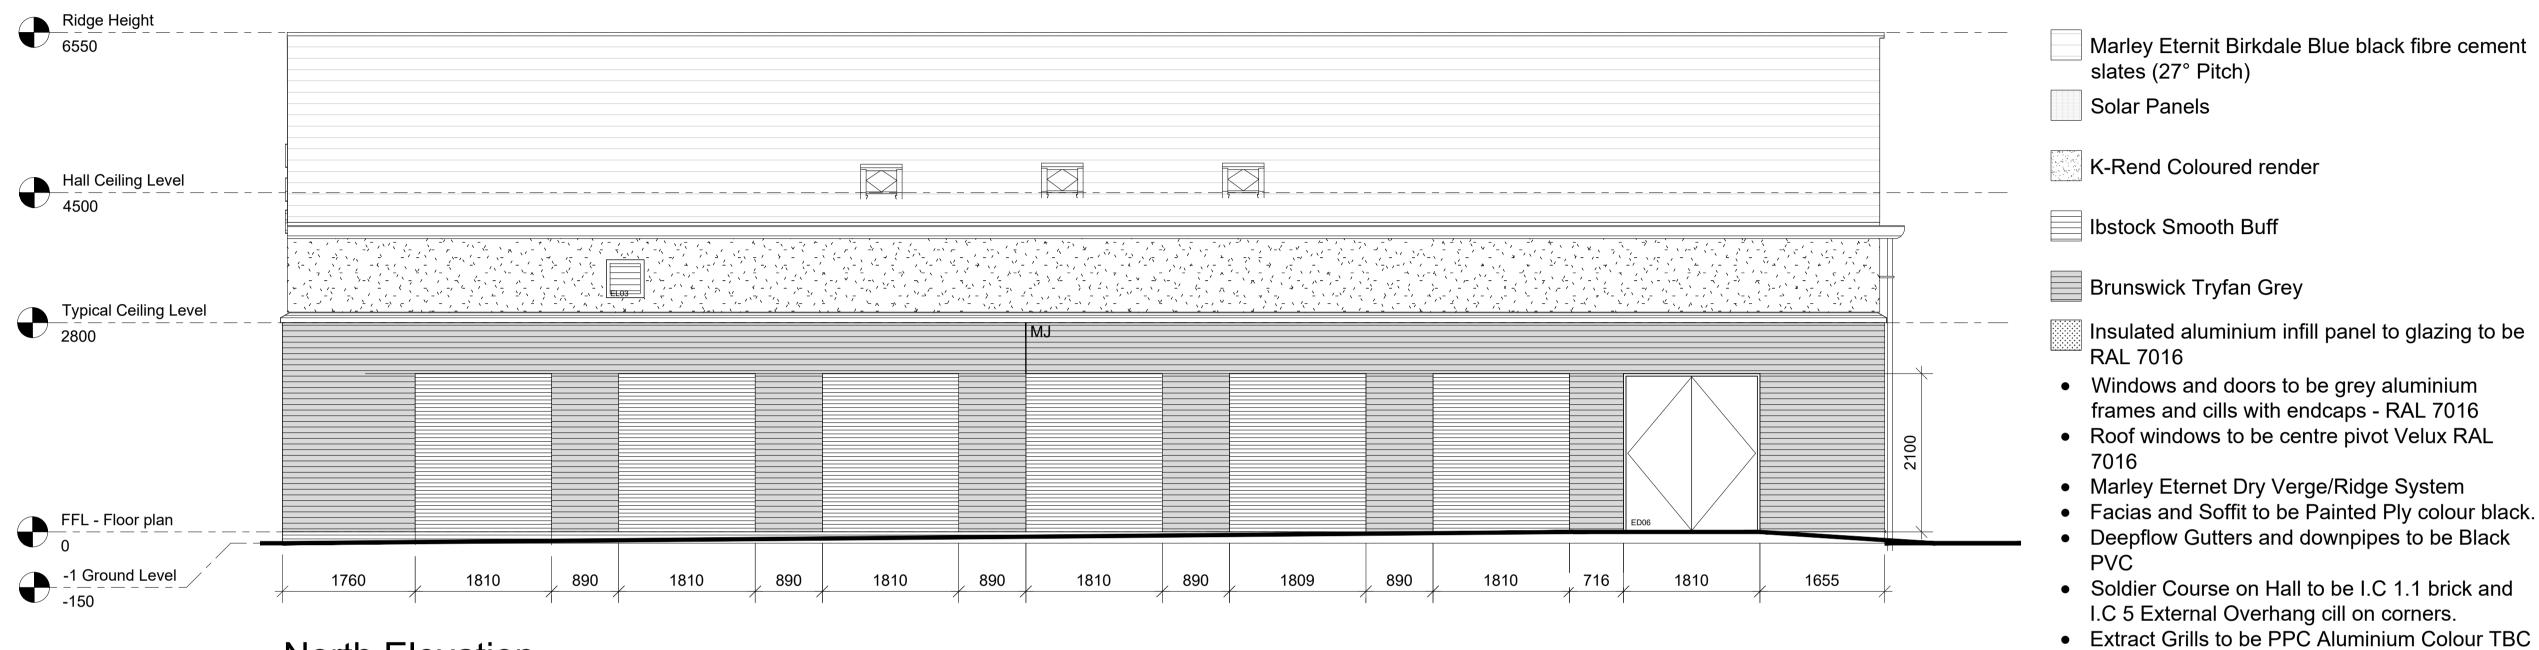

North Elevation



East Elevation

NOTES. 1. ALL DIMENSIONS IN MILLIMETRES (mm)
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ORDNANCE DATUM.

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Т	05.02.19	TENDER ISSUE	CJW
ev.	Date	Detail	App'd

PROJECT:

Marley Eternit Birkdale Blue black fibre cement

Insulated aluminium infill panel to glazing to be

frames and cills with endcaps - RAL 7016

I.C 5 External Overhang cill on corners.

slates (27° Pitch)

Solar Panels

RAL 7016

7016

## **Shotton Community** Centre

DRAWING TITLE:

## Proposed Elevations Sheet 2

CLIENT:

## **Shotton Parish Council**

STATUS:	TENDER			
Design:	MD	RVT:	EMN	
Chk'd by:	CJW	App'd:	CJW	
Date: Ja	an 19	Scale:	1 : 100	(@ A3)
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