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# SHOTTON COLLIERY COMMUNITY CENTRE




Date		Rev
31-01-19	Issued for Tender	T

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Drg. No. 1442/L(-1)01 Scale: 1/1250@A4 November 2017



- NOTES:
1. ALL DIMENSIONS IN MILLIMETRES (mm) UNLESS NOTED OTHERWISE.
  2. ALL LEVELS ARE IN METRES (m) ABOVE ORDNANCE DATUM.
  - 3 THIS DRAWING SHOULD BE READ IN CONJUNCTION WITH THE GENERAL ARRANGEMENT DRAWING.

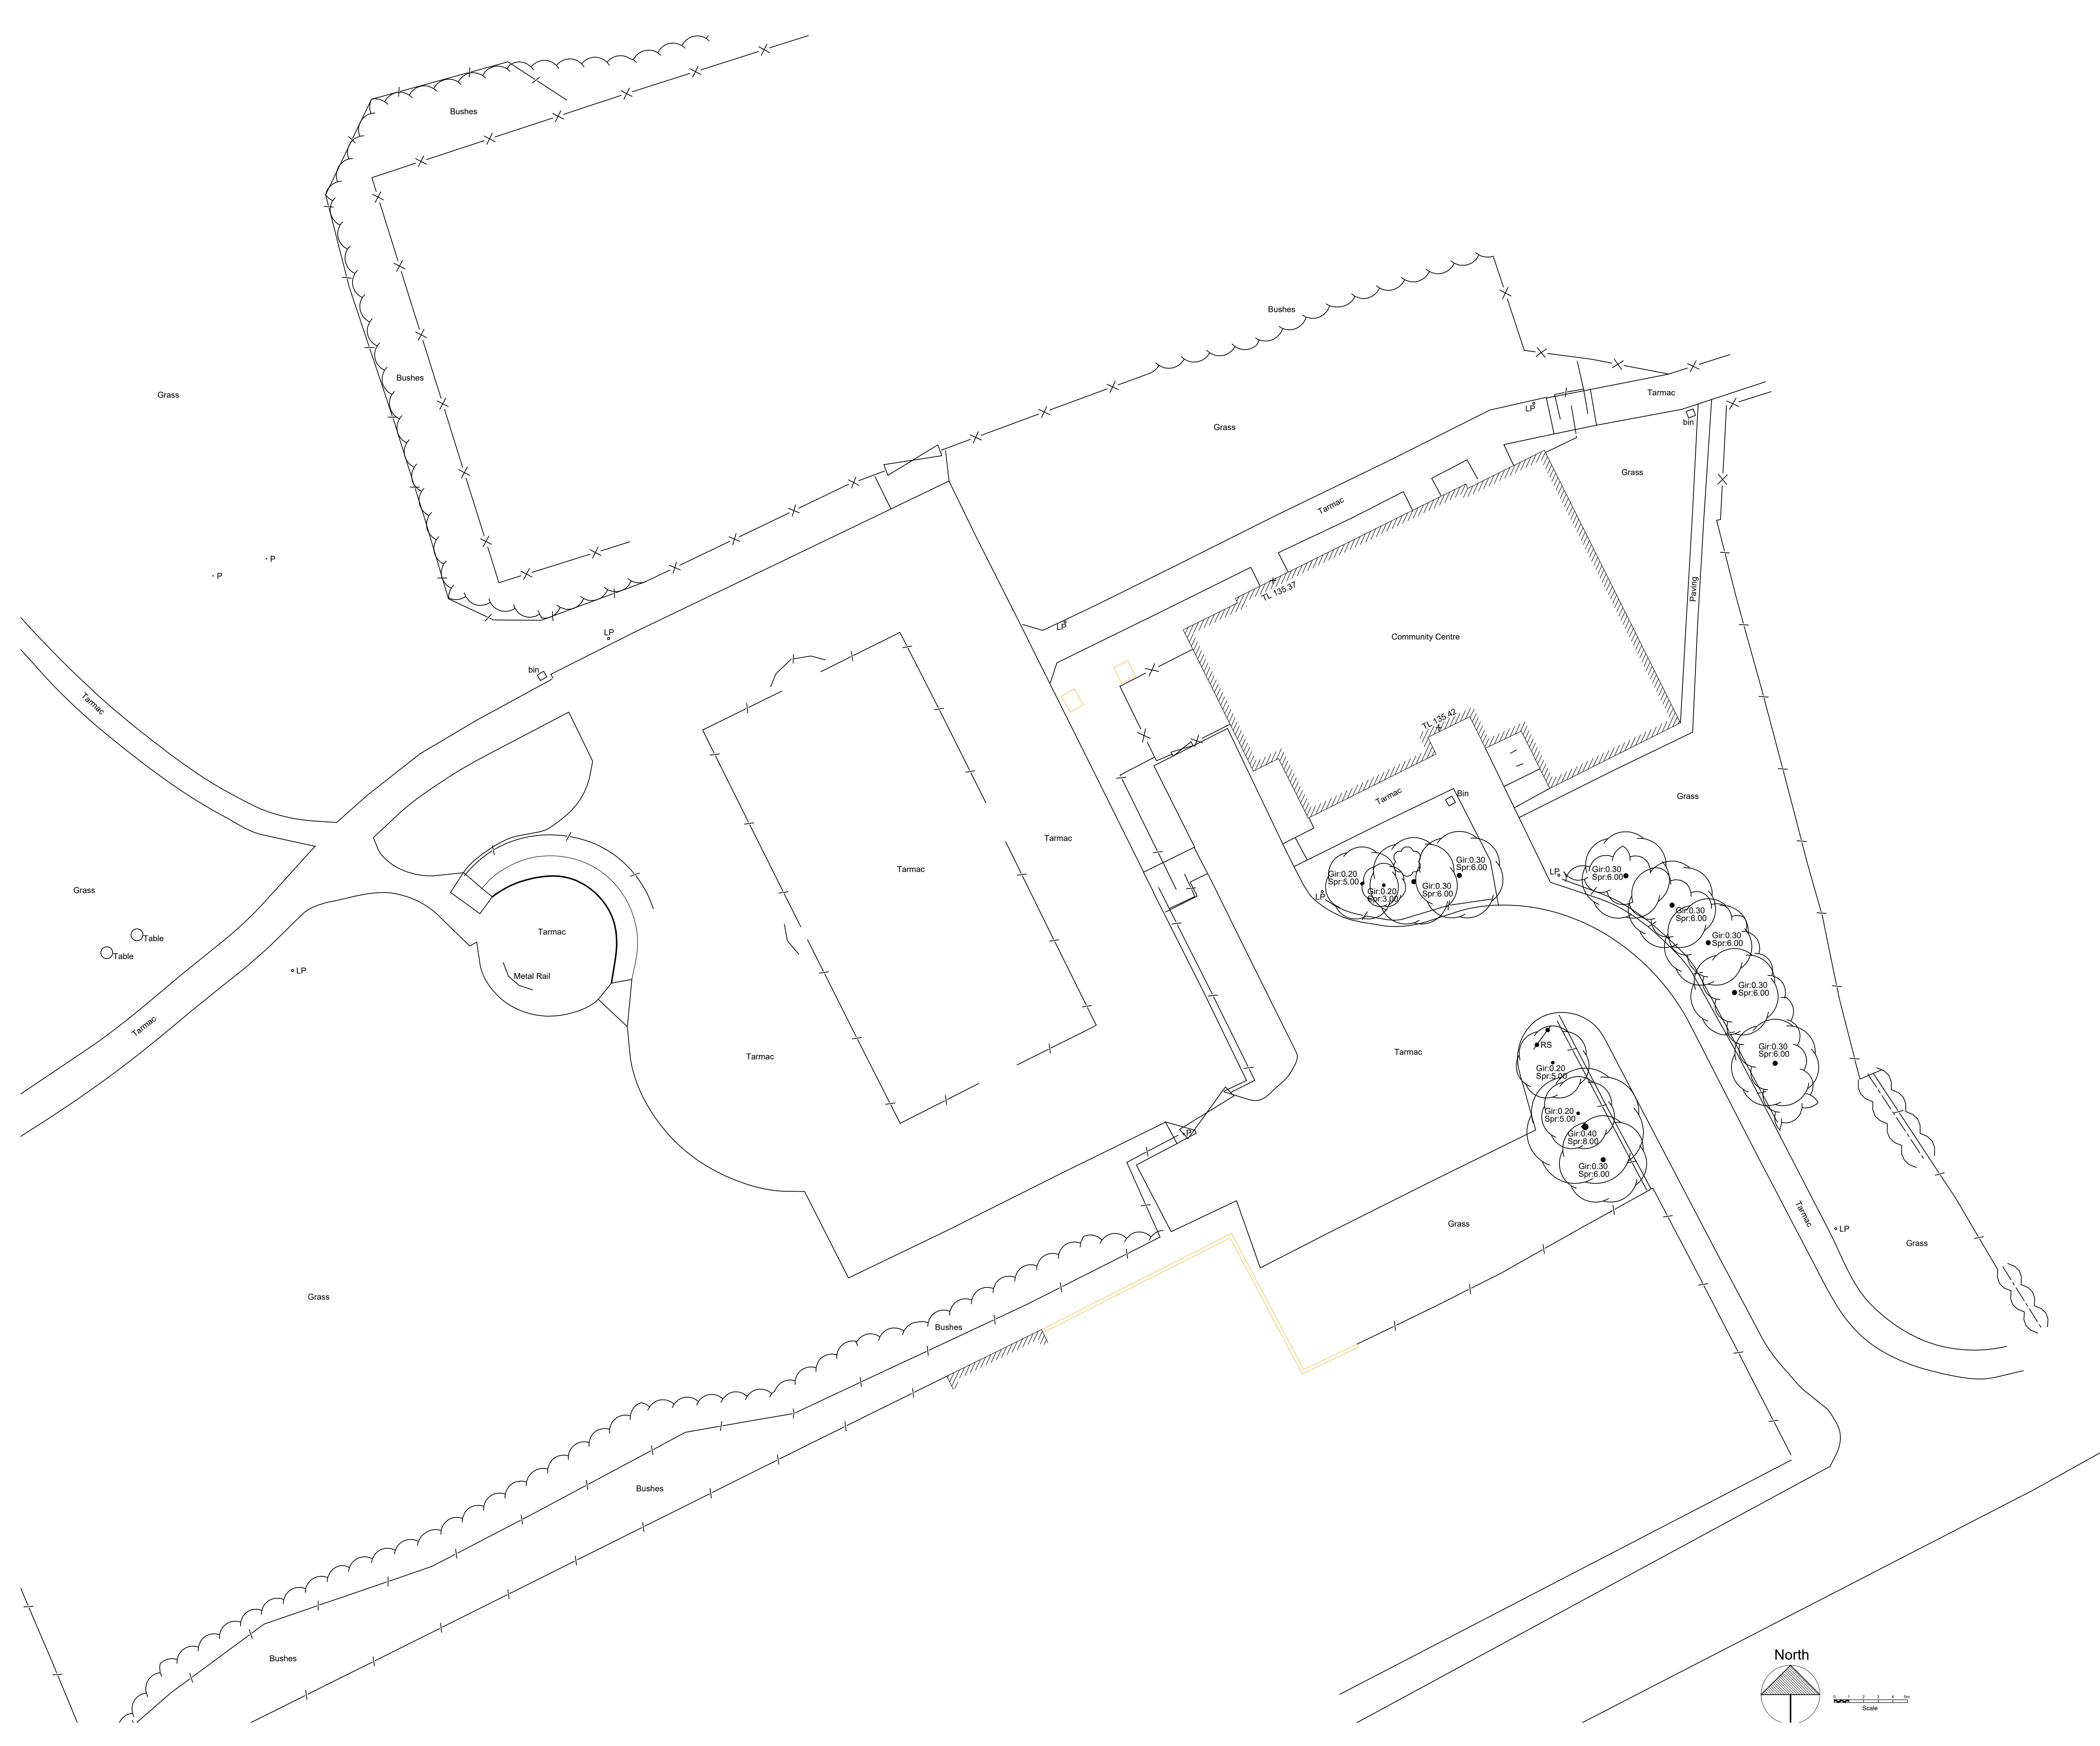T	31-01-19	Issued for Tender	MD
Rev.	Date	Details	App'd

PROJECT TITLE:

SHOTTON COMMUNITY CENTRE

DRAWING TITLE:

Existing Site Plan

CLIENT:

Shotton Parish Council

STATUS: TENDER	
Design: SGeo	CAD: WS
Chk'd: MRD	App'd: MRD
Date: 25.07.18	Scale: 1:200 @A1





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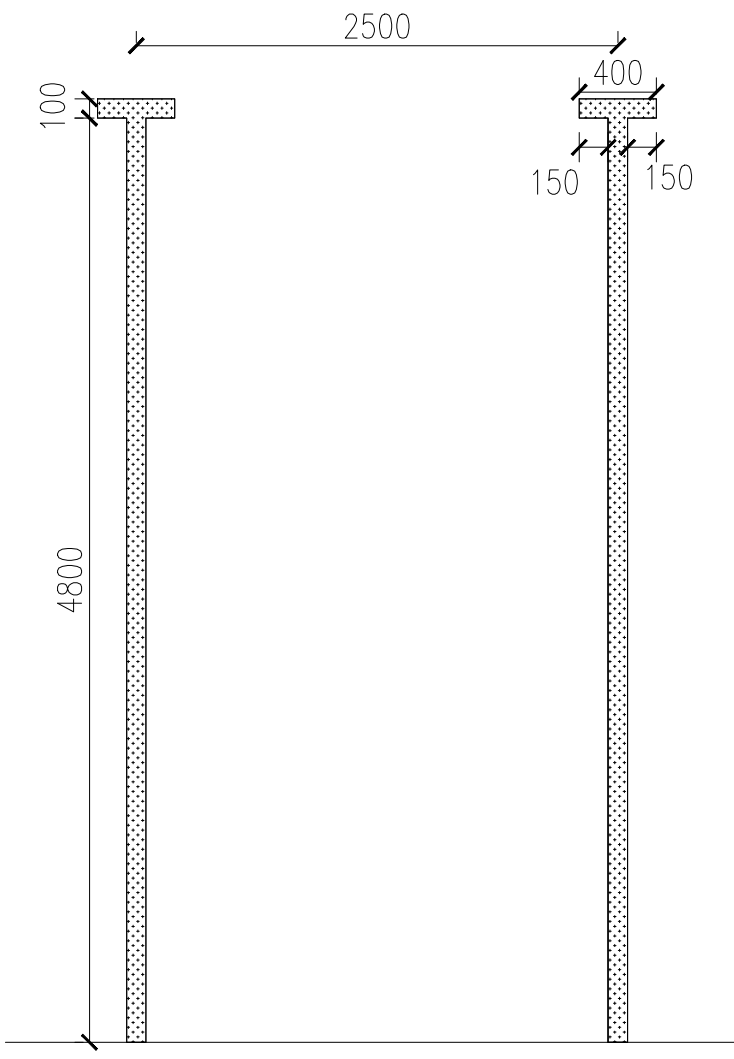
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Project no:	Drg no:	Rev:
1442	L(-1)02	T





TYPICAL ACC. PARKING BAY SETTING OUT

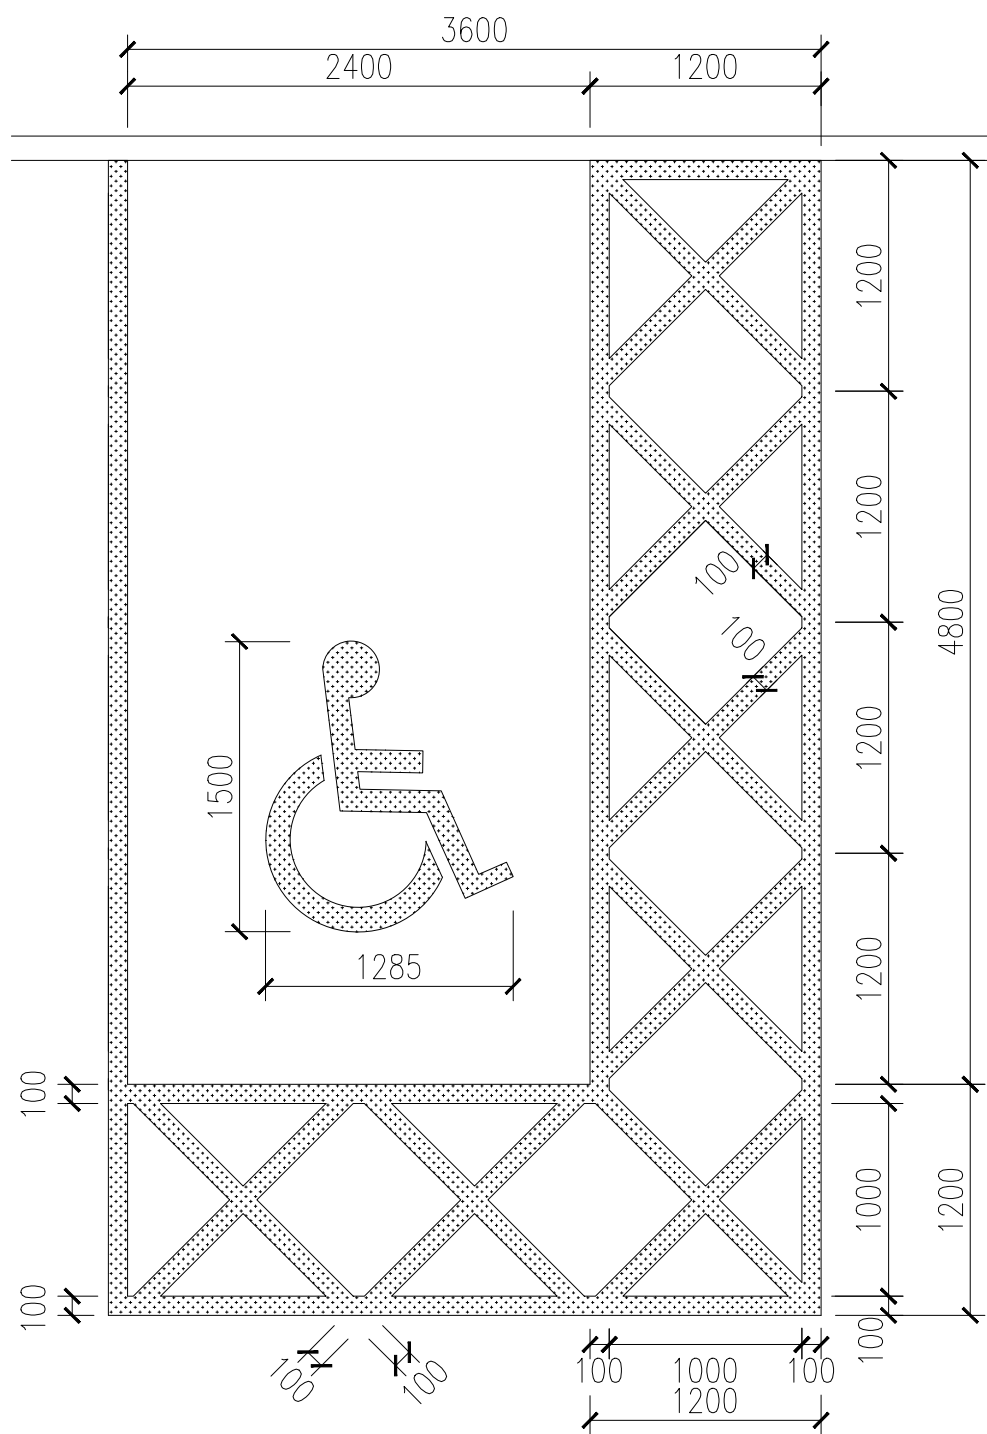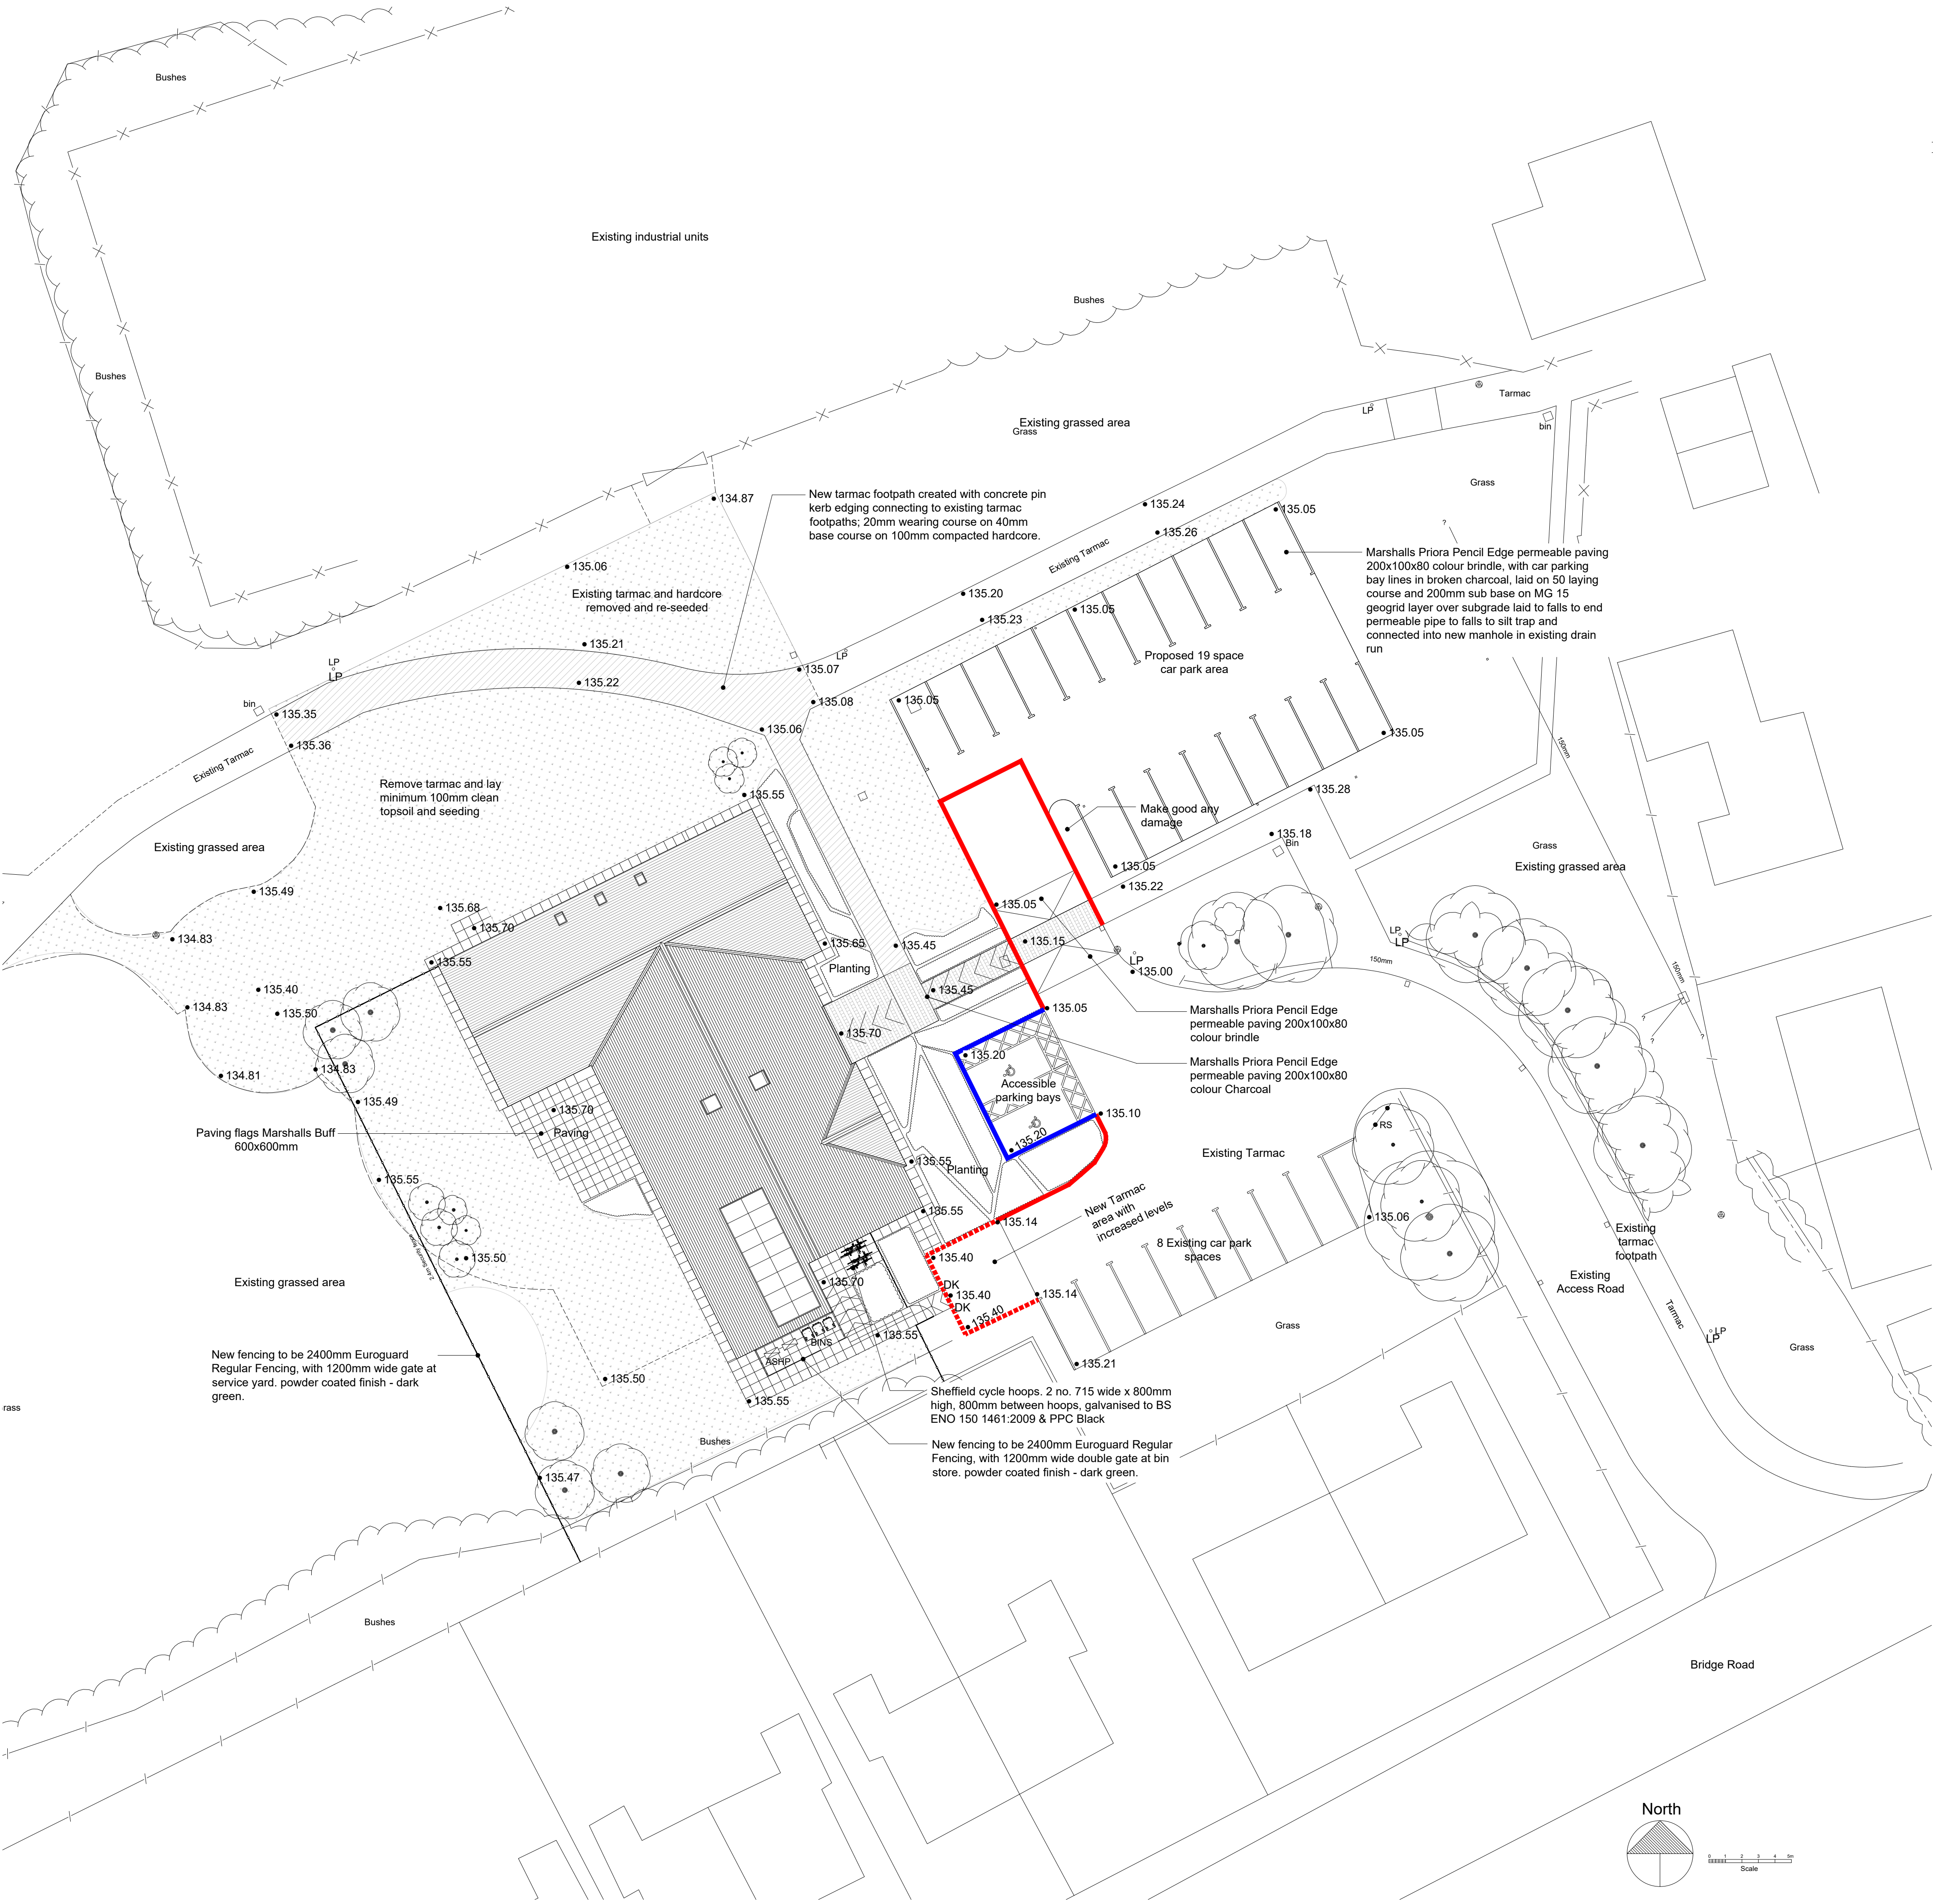

TYPICAL PARKING BAY SETTING OUT

- REMOVE EXISTING KERBS AND INSTALL NEW HALF BATTERED KERB
- INSTALL NEW HALF BATTERED KERB INCLUDING DROP KERBS (DK) TO NEW LEVELS
- INSTALL NEW HALF BATTERED KERB

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T	28-01-19	TENDER ISSUE	MD
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PROJECT TITLE:

SHOTTON COMMUNITY CENTRE

DRAWING TITLE:

PROPOSED SITE PLAN

CLIENT:

Shotton Parish Council

STATUS: TENDER

Design: SGeo	CAD: WS
Chk'd: MRD	App'd: MRD
Date: 31.01.19	Scale: 1:200 @A1


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Project no:	Drg no:	Rev:
1442	L(92)001	T





Footpath Diversion

- supply, install and maintain 2 no., advance warning footpath closure signs 2 weeks prior to works commencing.
- supply, install and maintain footpath diversion signage for the duration of the works (refer to construction management plan).

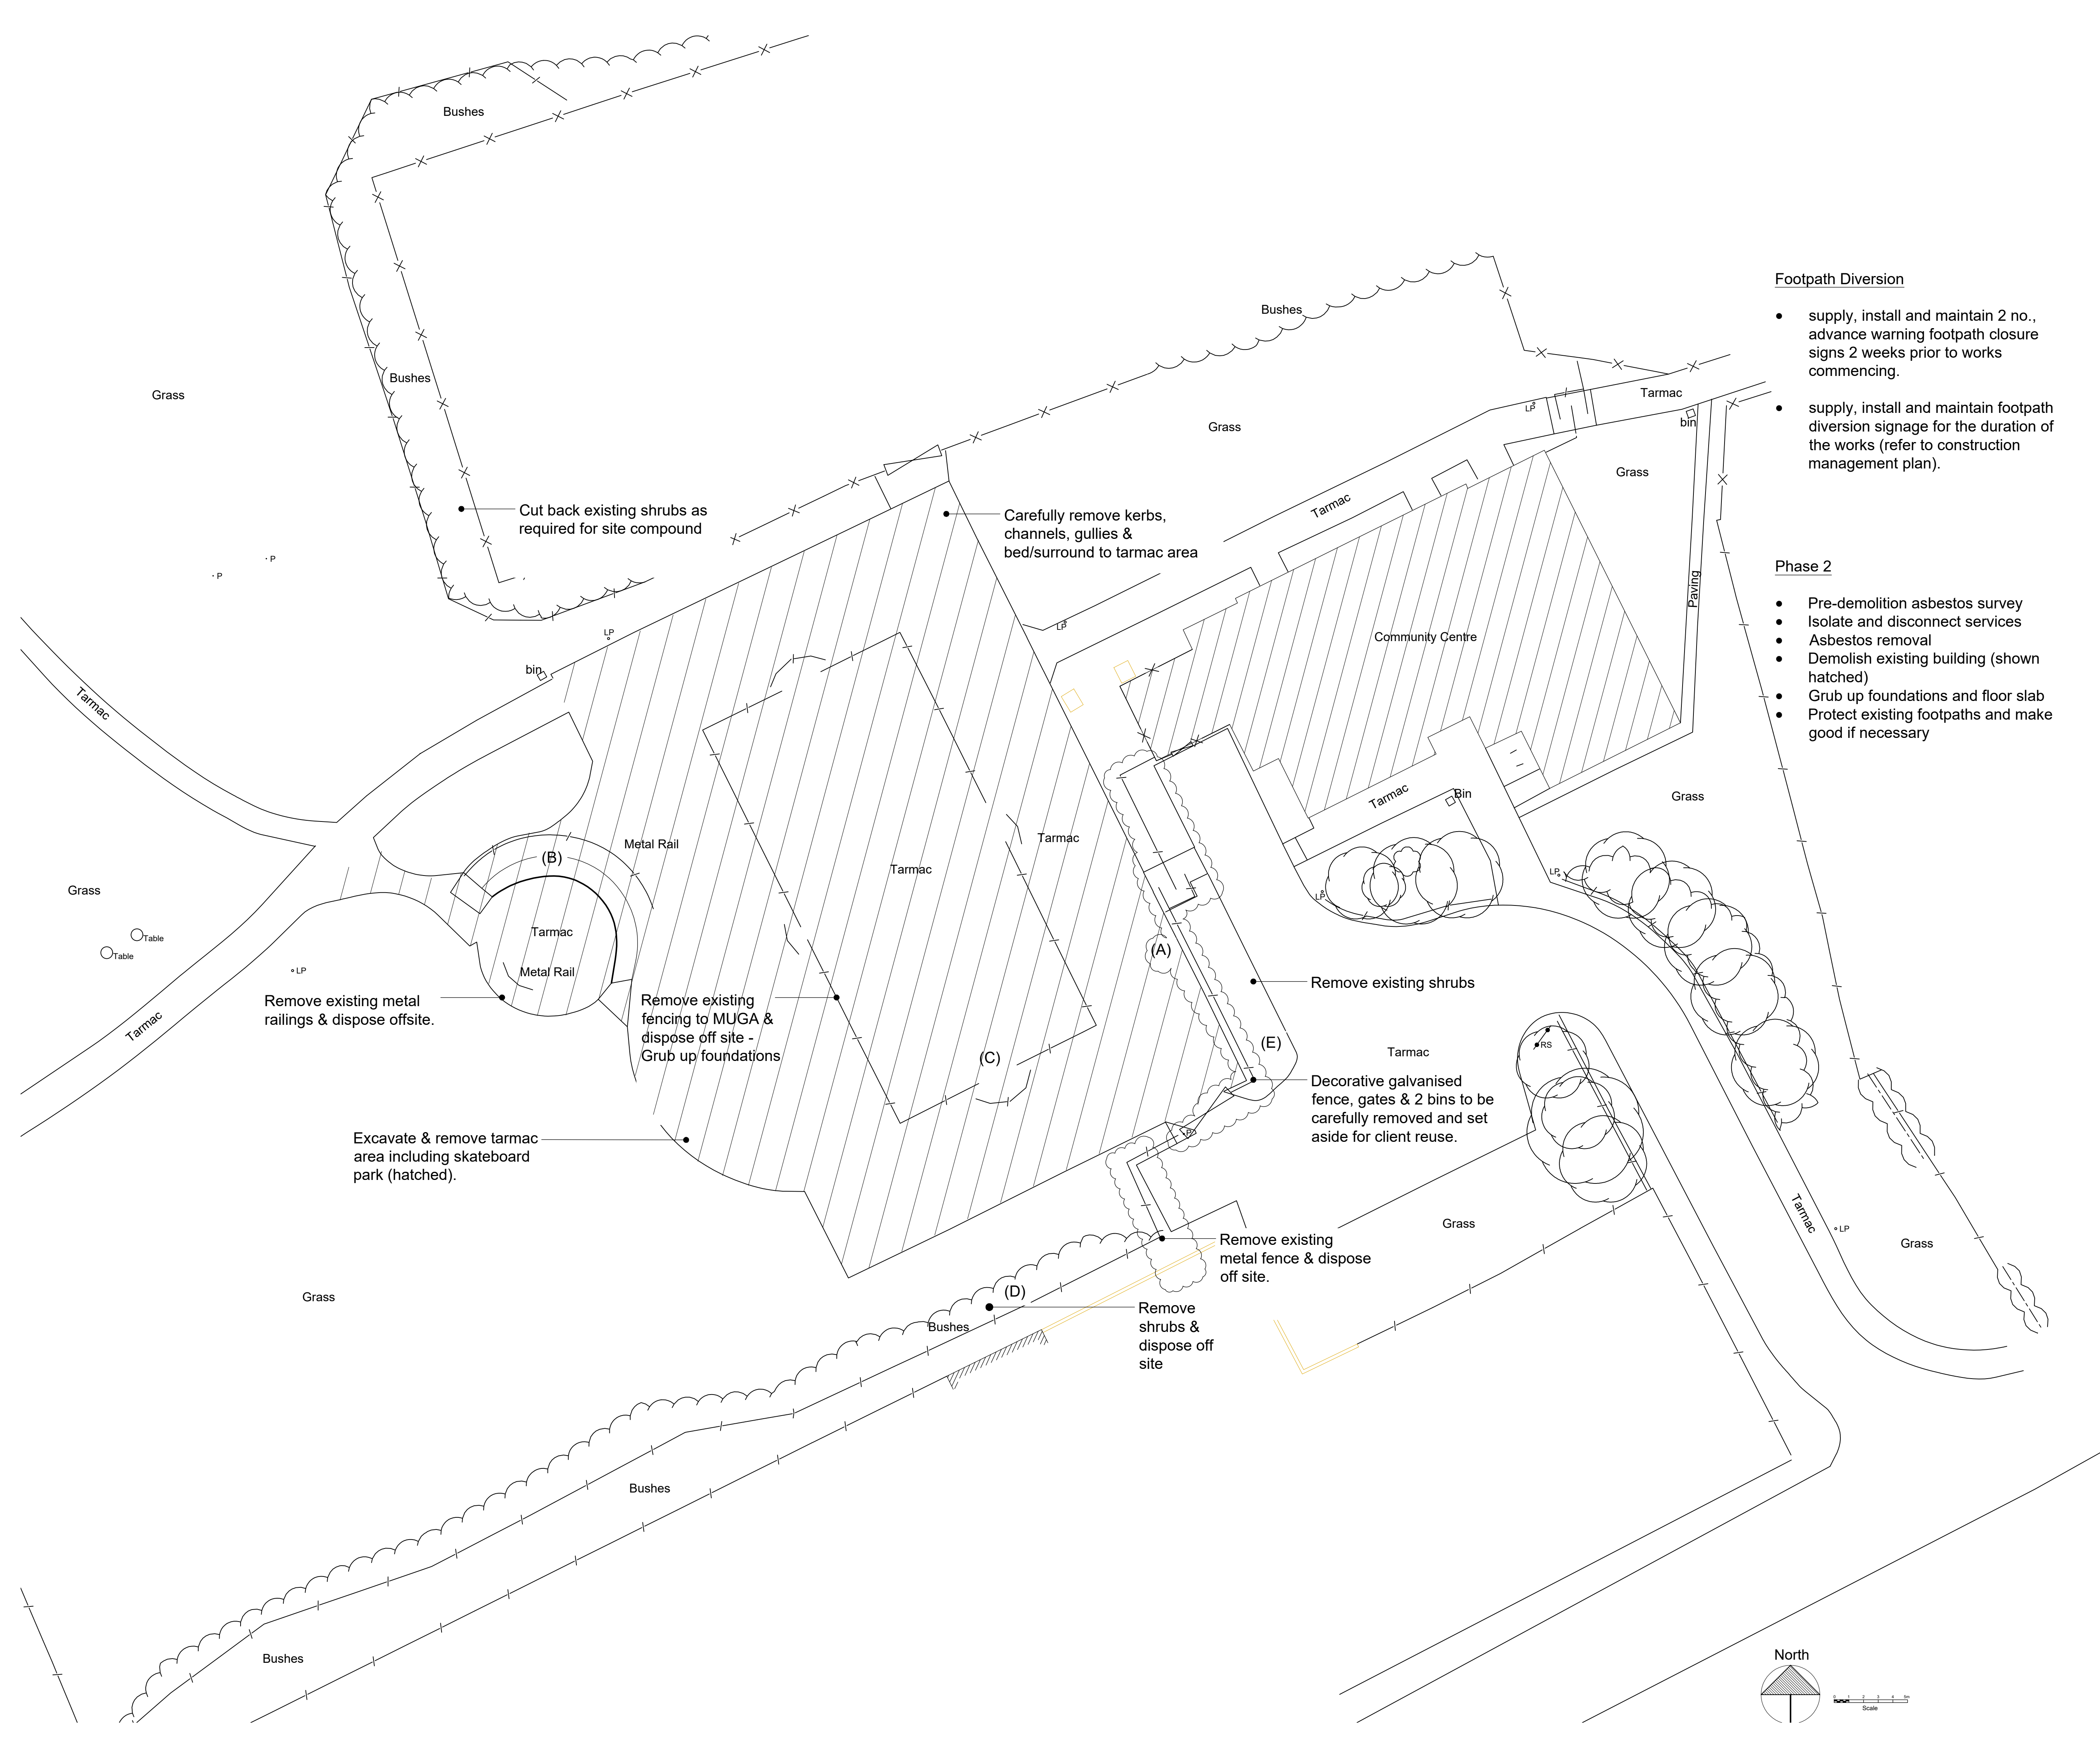Phase 2

- Pre-demolition asbestos survey
- Isolate and disconnect services
- Asbestos removal
- Demolish existing building (shown hatched)
- Grub up foundations and floor slab
- Protect existing footpaths and make good if necessary

NOTES.

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T	31-01-19	Issued for Tender	CJW
Rev.	Date	Details	App'd

PROJECT TITLE:

SHOTTON COMMUNITY CENTRE

DRAWING TITLE:  
Phase 1 and Phase 2

Enabling Works

CLIENT:

Shotton Parish Council

STATUS: TENDER

Design: CJW	CAD: CJW
Chk'd: MRD	App'd: MRD
Date: 25.07.18	Scale: 1:200 @A1




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Project no: 1442	Drg no: L(-1)102	Rev: T
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NOTES.

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T	05-02-19	Issued for Tender	CJW
Rev.	Date	Details	App'd

PROJECT TITLE:

SHOTTON COMMUNITY CENTRE

DRAWING TITLE:

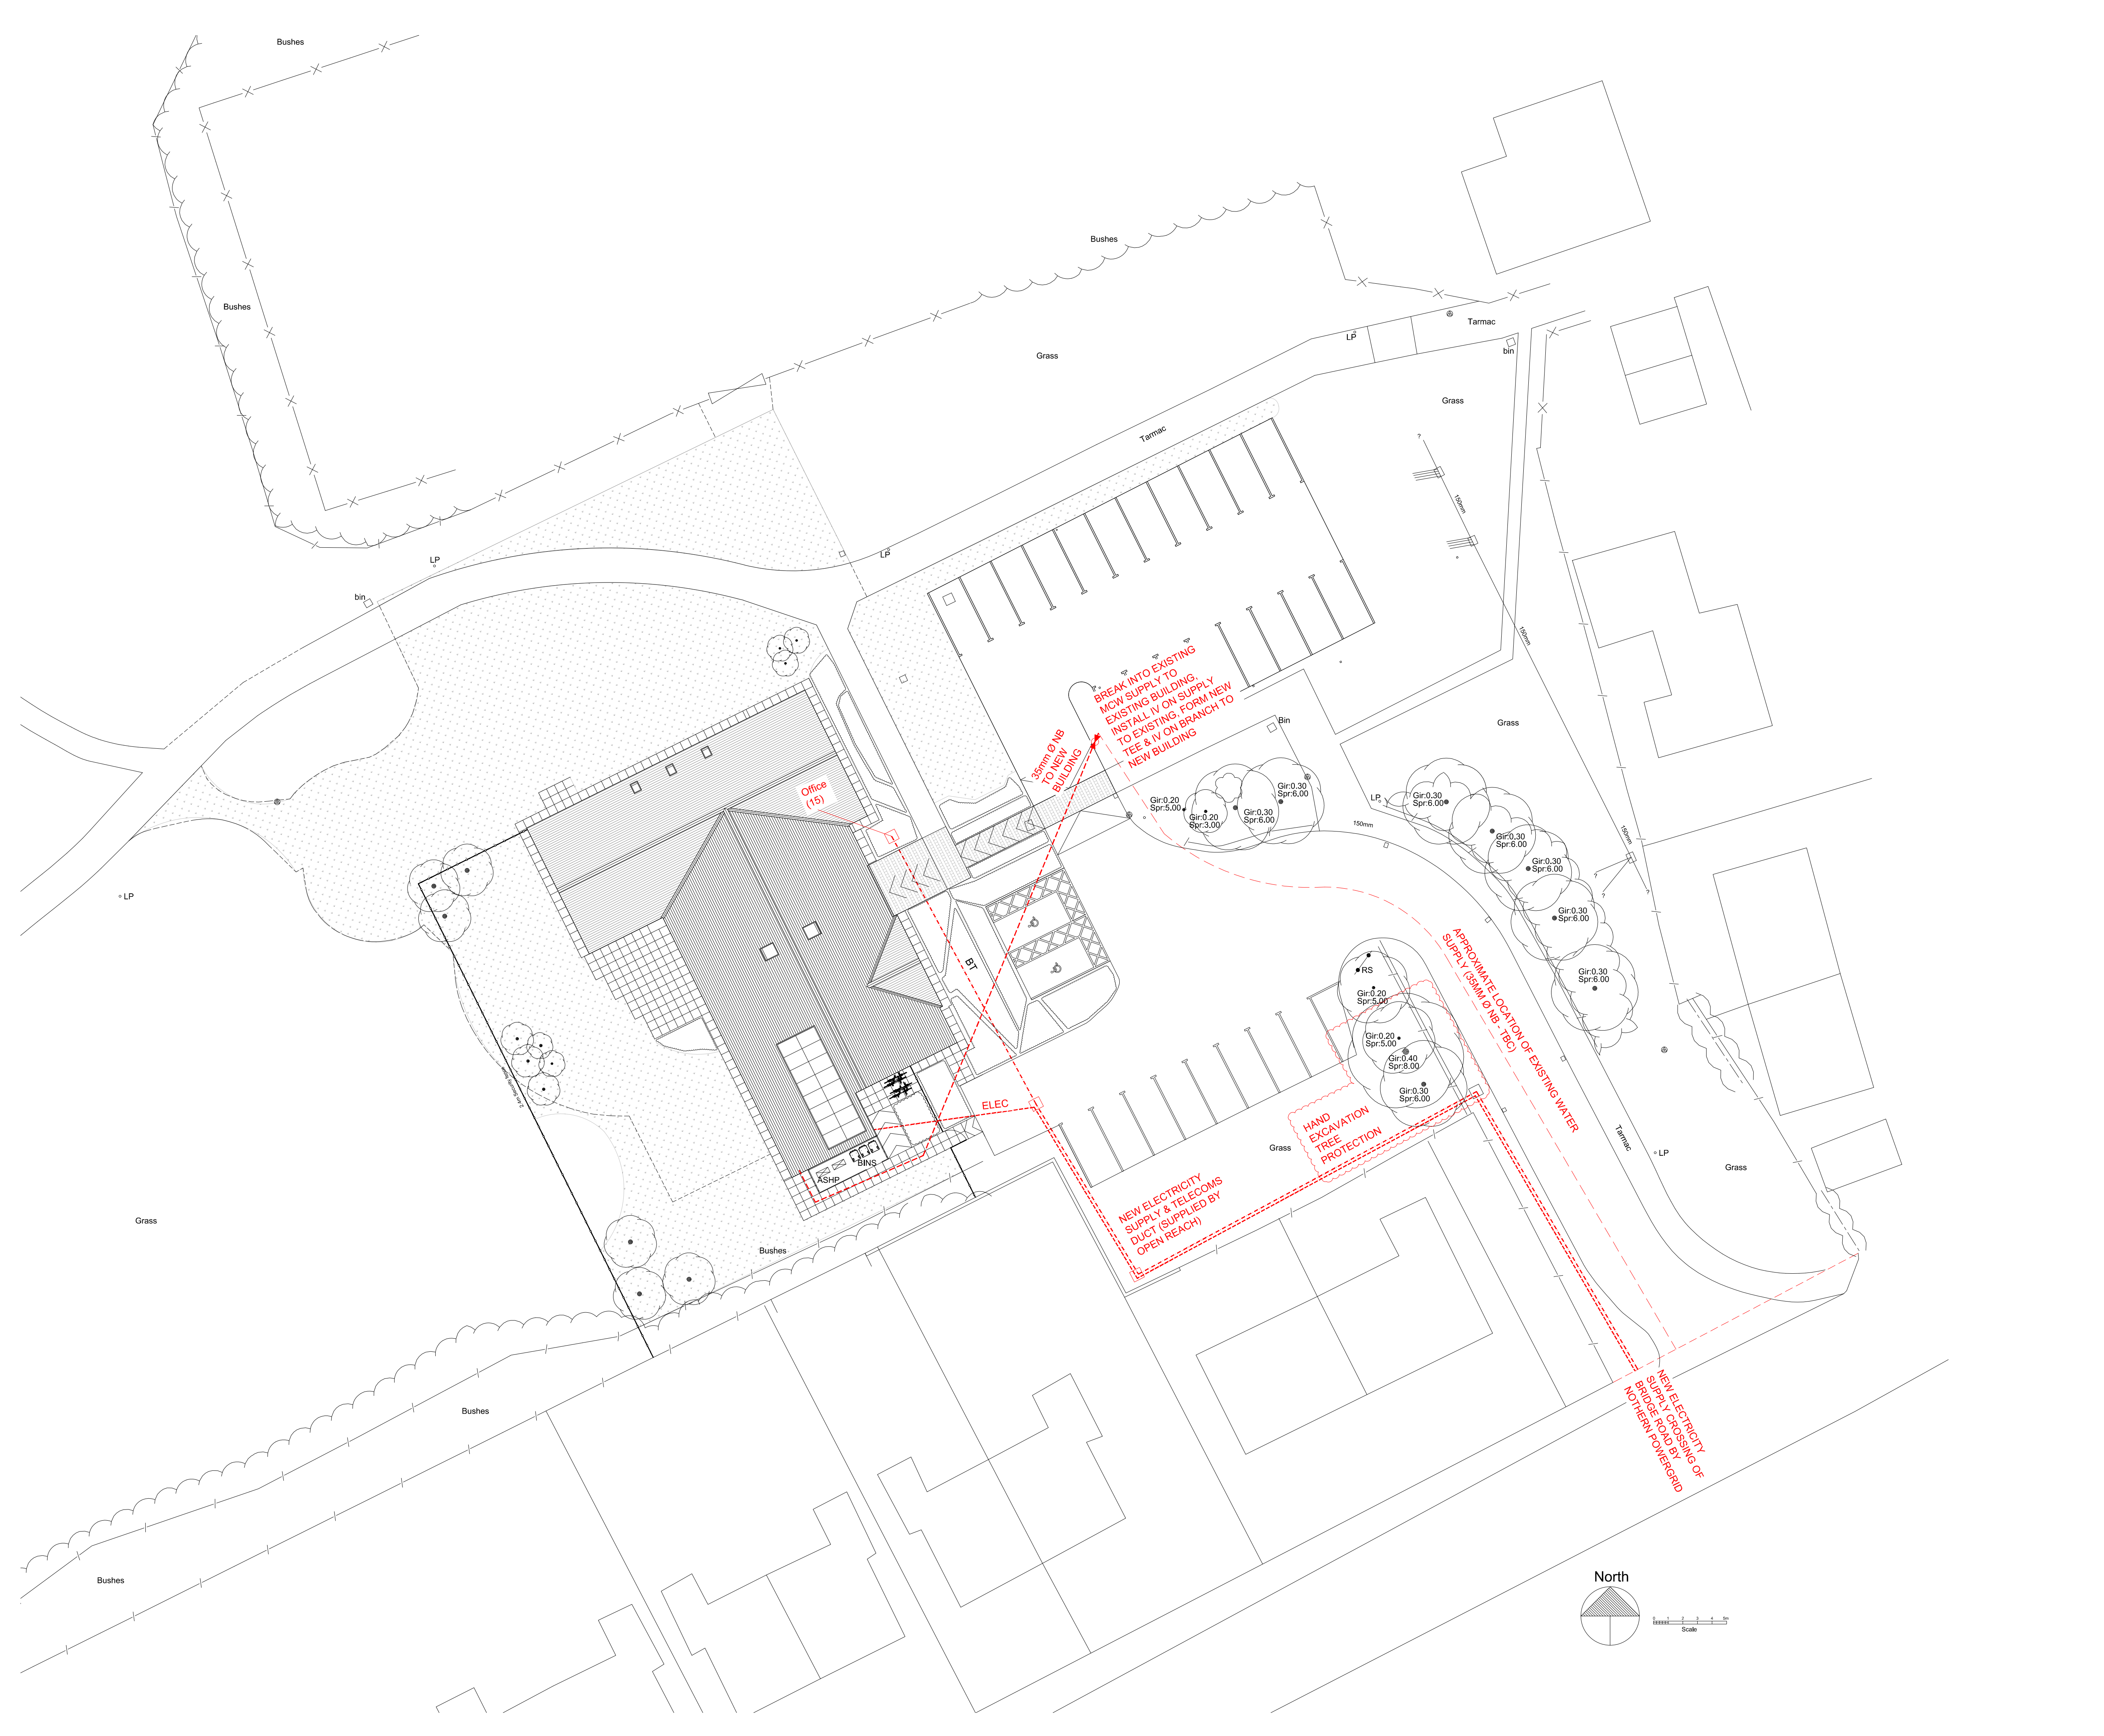
UTILITY CONNECTIONS

PROPOSED PLANS

CLIENT:

Shotton Parish Council

STATUS: TENDER	
Design: CJW	CAD: CJW
Chk'd: MRD	App'd: MRD
Date: 25.07.18	Scale: 1:200 @A1



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Project no: 1442	Drg no: L(-1)104	Rev: T
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T	29-01-19	Issued for Tender	CJW
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PROJECT TITLE:

## SHOTTON COMMUNITY CENTRE

DRAWING TITLE:


## Proposed Drainage Plan

CLIENT:

Shotton Parish Council

STATUS: TENDER

Design: CJW	CAD: CJW
Chk'd: MRD	App'd: MRD
Date: 25.07.18	Scale: 1:200 @A1



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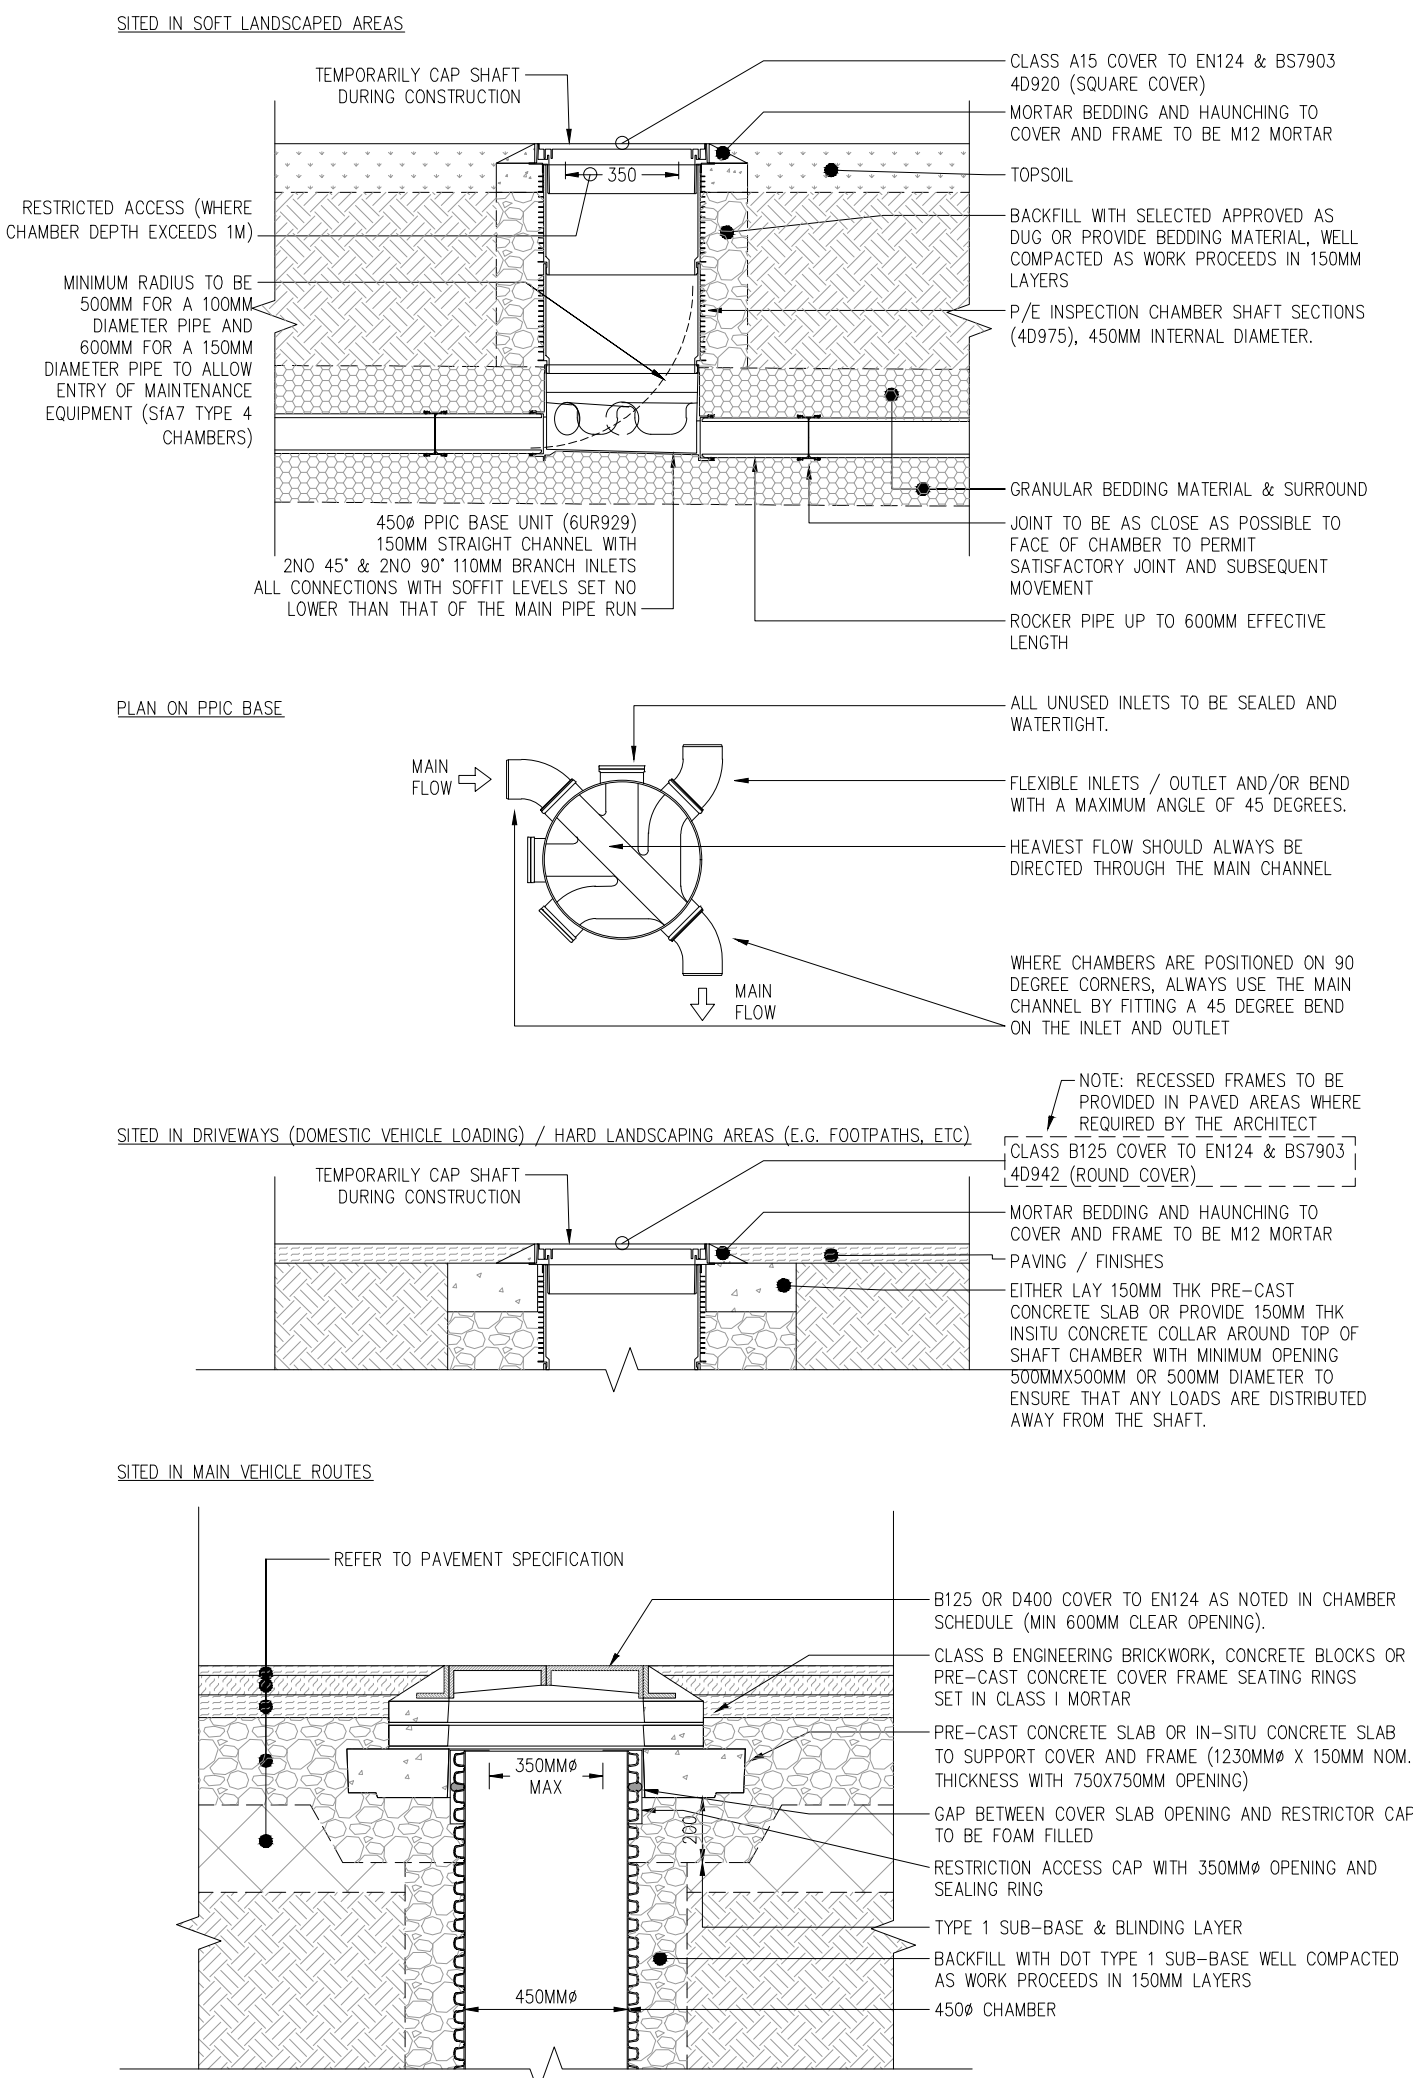
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Project no:	Drg no:	Rev:
1442	L(-1)105	T







POLYPROPYLENE INSPECTION CHAMBERS – OSMa 450Ø UNIVERSAL IC (WAVIN)  
DEPTHS UP TO 1.2M, 100Ø/150Ø PIPES




1240X675 BRICK MANHOLE CHAMBER

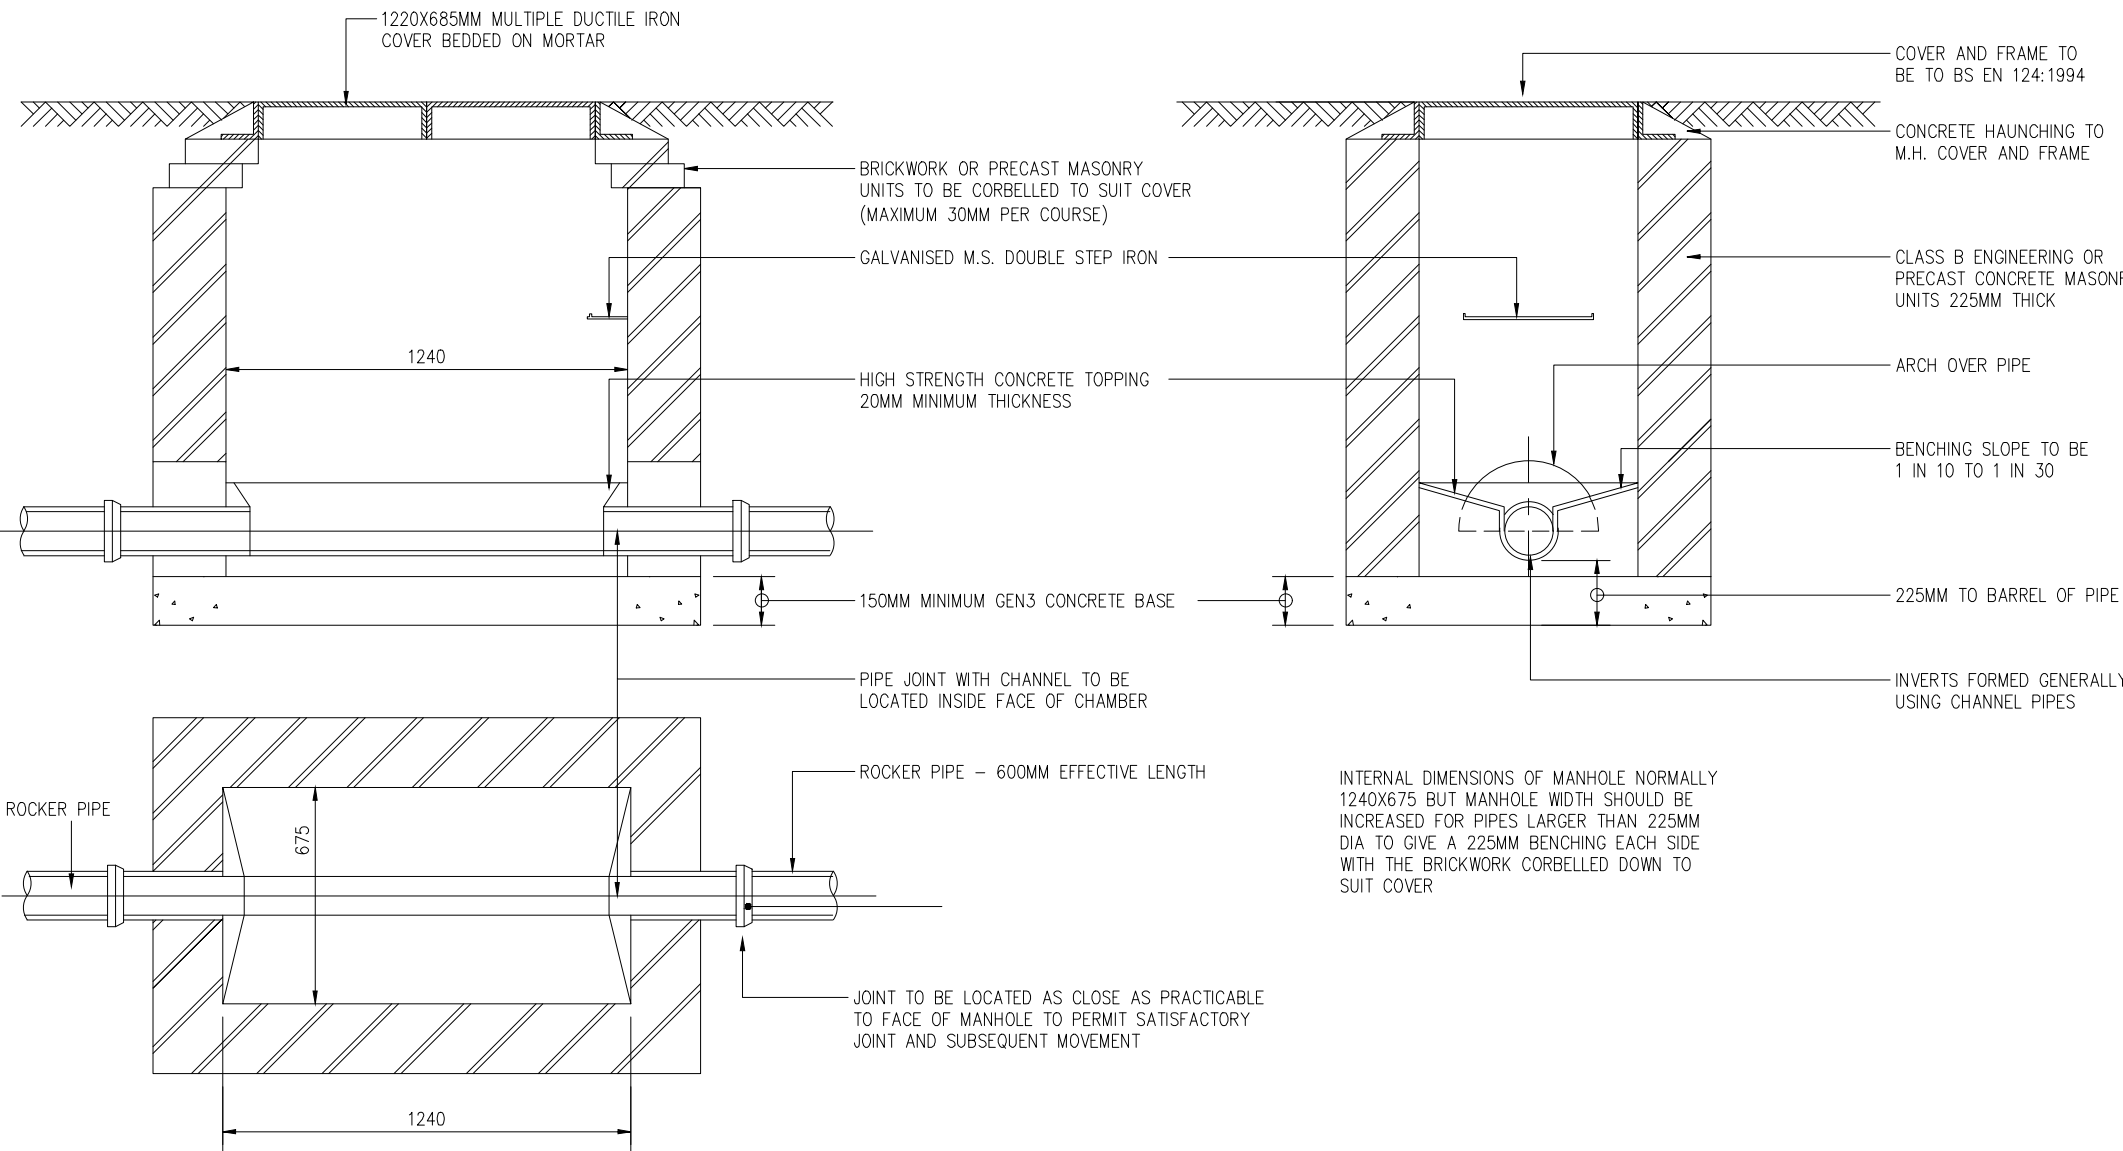


PRECAST CONCRETE MANHOLE CHAMBERS  
[DEPTH FROM GROUND LEVEL  
TO SOFFIT OF PIPE UP TO 3.00M]

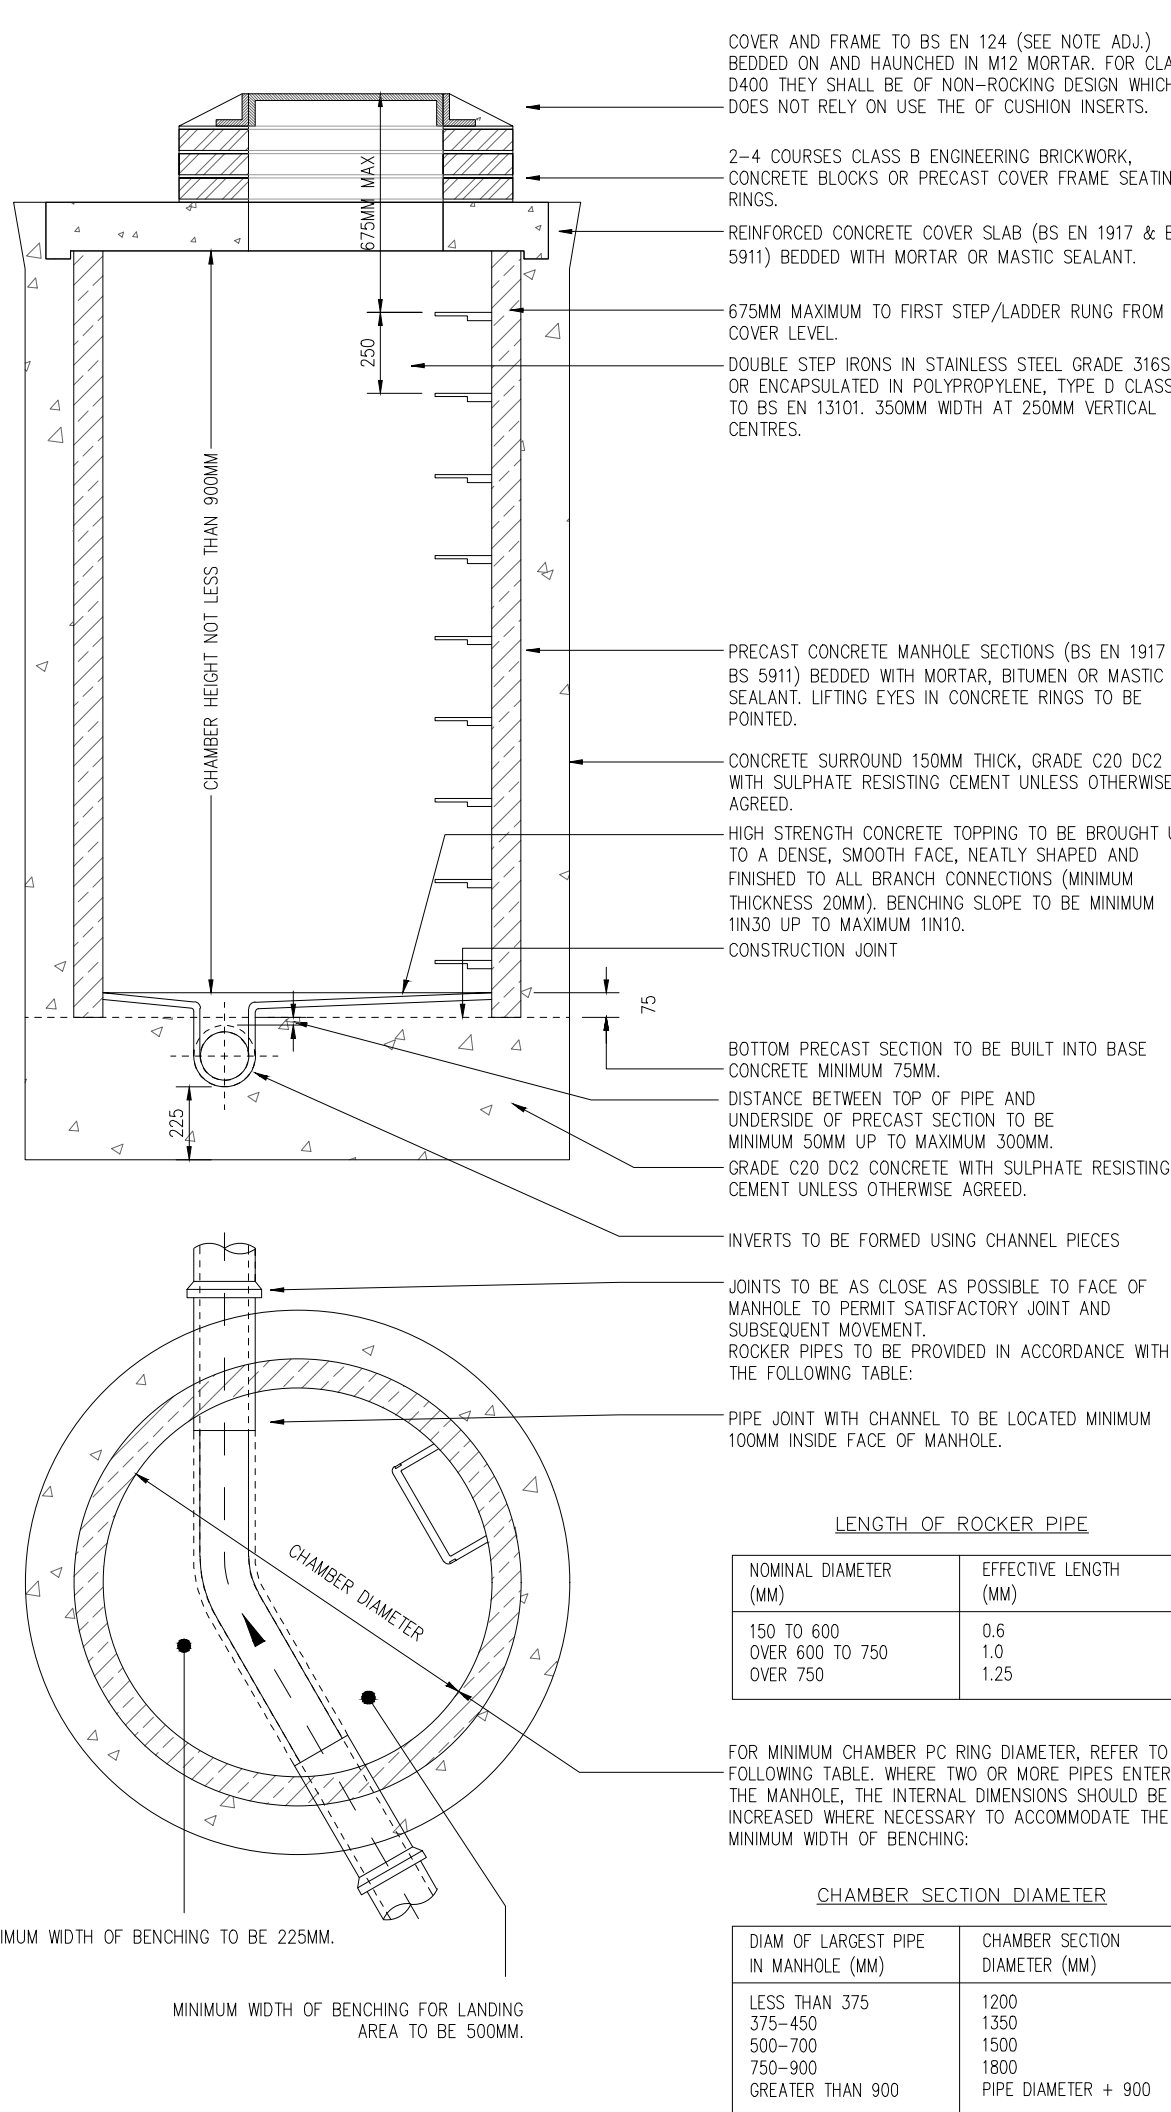


PRECAST CONCRETE CATCHPIT CHAMBER  
[DEPTH FROM GROUND LEVEL TO SOFFIT OF PIPE  
UP TO 2.00M, PIPE DIAMETER UP TO 375MM]

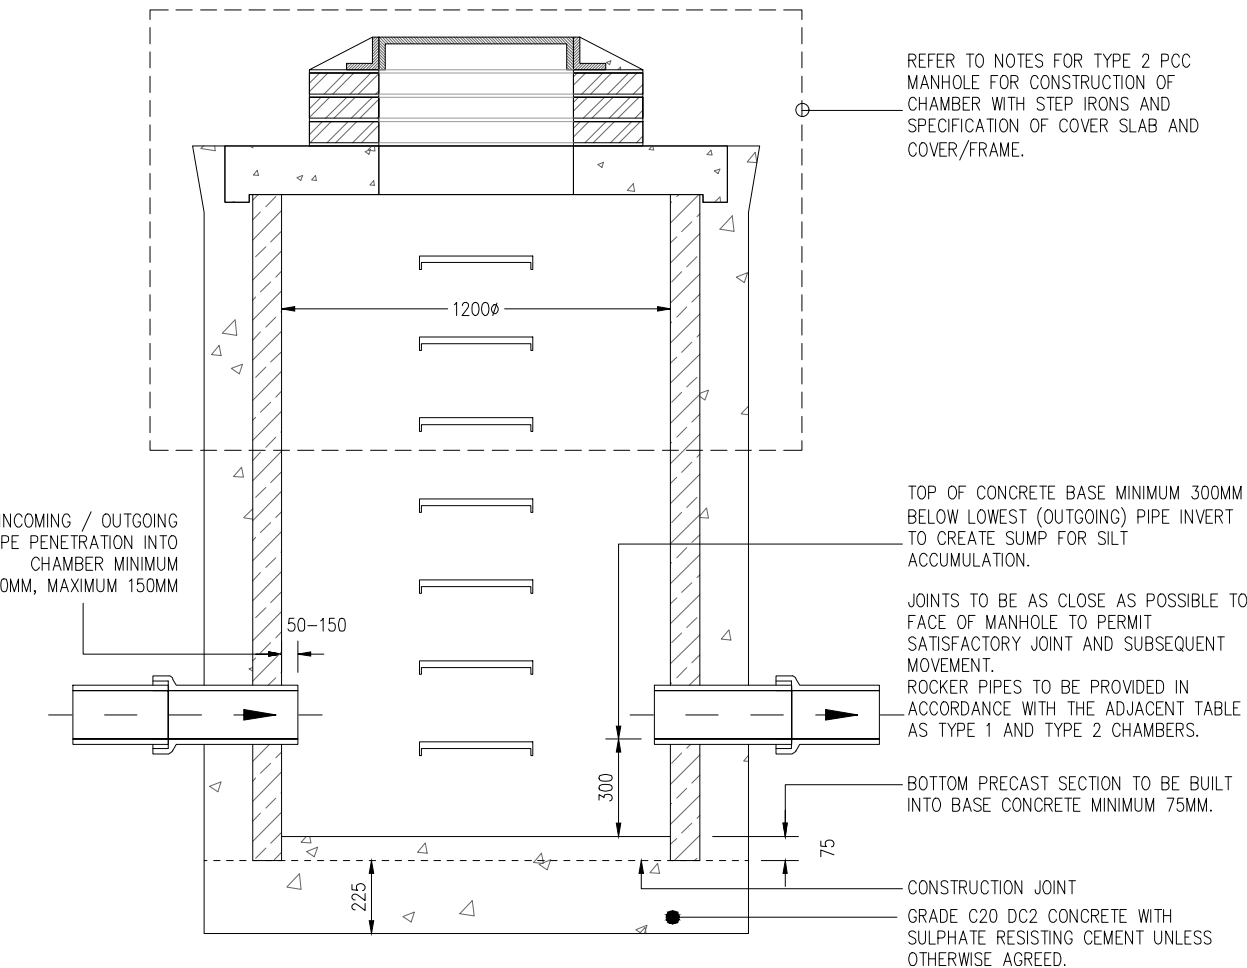

SILT TRAP (WAVIN 6LB600)

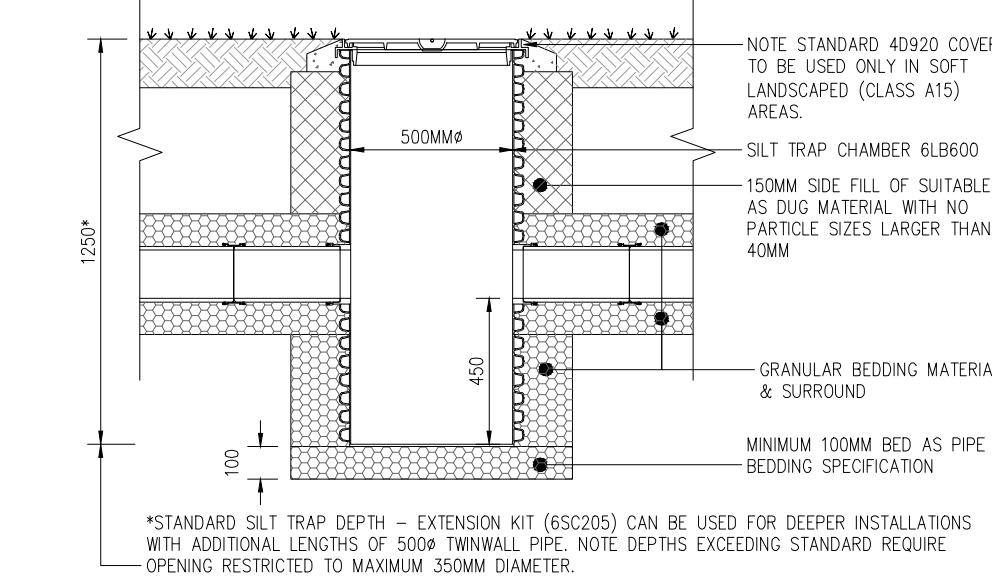

250Ø SILT TRAP  
[WAVIN 6LB300, 100Ø PIPES]

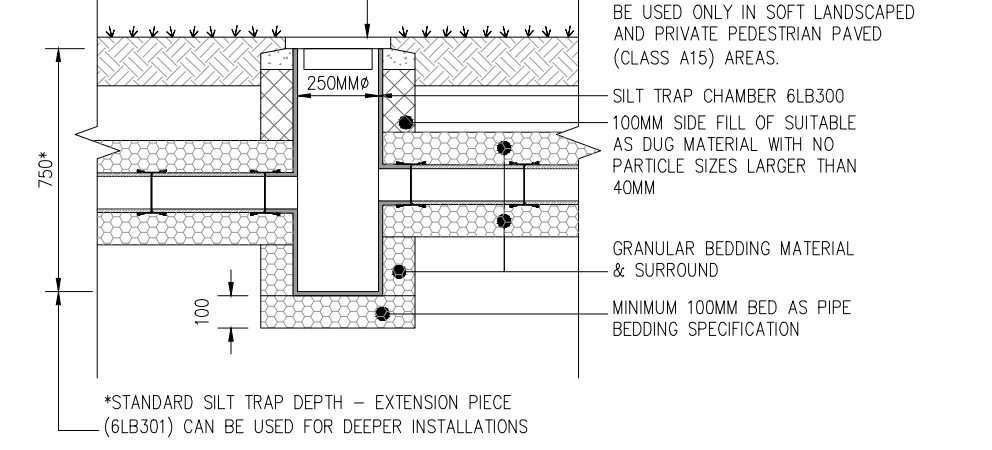

GENERAL NOTES:

- ALL DIMENSIONS IN MILLIMETRES
- THIS DRAWING IS TO BE READ IN CONJUNCTION WITH ALL OTHER RELEVANT PROJECT DRAWINGS (ARCHITECTURAL, M&E ETC).
- ALL BELOW GROUND DRAINAGE WORKMANSHIP TO BE CARRIED OUT IN STRICT ACCORDANCE WITH BS 8000 'WORKMANSHIP OF BUILDING SITES, PART 14: CODE OF PRACTICE FOR BELOW GROUND DRAINAGE'.
- EXACT LOCATIONS AND CURRENT USAGE OF ALL EXISTING DRAINAGE TO BE ESTABLISHED ON COMMENCEMENT OF ANY WORKS.
- ALL NEW BELOW GROUND DRAINAGE WORKS TO BE INSPECTED AND APPROVED BY BUILDING CONTROL PRIOR TO BACKFILLING.

PIPEWORK:

- ALL PIPEWORK TO HAVE CLASS S GRANULAR BED AND SURROUND AS FOLLOWS (UNLESS REQUIRED OTHERWISE – REFER TO NOTE 9 BELOW).
  - BEDDING THICKNESS 150 MIN BELOW PIPE AND 100MM MIN BELOW SOCKETS TO BE LIGHTLY COMPACTED OVER FULL WIDTH OF TRENCH.
  - WHERE TRENCH BOTTOM IS UNEVEN DUE TO HARD SPOTS OR OTHER REASONS, INCREASE DEPTH BY 100MM, SCOOP OUT LOCALLY AT COUPLINGS / SOCKETS AND LAY PIPES DIGGING INTO BED AND RESTING UNIFORMLY ON THEIR BARRELS, ADJUST TO LINE AND GRADIENT.
  - AFTER INITIAL TESTING, LAY AND COMPACT MORE GRANULAR MATERIAL IN 100MM LAYERS TO 150MM (300MM FOR ADAPTABLE SEWERS) ABOVE CROWN OF PIPE.
  - GRANULAR MATERIAL TO WIS 4-08-01, TABLE A1 (RIGID PIPELINES), AND COMPLYING WITH WIS 4-08-02, RECYCLED MATERIALS COMPLYING WITH BS8500-2.
- CONCRETE SURROUND (CLASS Z);
  - MIN CONCRETE GRADE GEN 3 (C20 STRENGTH)
  - LAY CONCRETE BLINDING 25MM OVER FULL TRENCH AND ALLOW TO SET.
  - LAY PIPES ON BLINDING ON FOLDED WEDGES OF COMPRESSIBLE BOARD NOT LESS THAN 100MM ABOVE BLINDING.
  - FORM VERTICAL CONSTRUCTION JOINTS IN SURROUND AT FACE OF PIPE JOINT USING 18MM COMPRESSIBLE BOARD PRECUT TO PROFILE OF PIPE (PIPES LESS THAN 450MM DIA). FILL ANY GAP BETWEEN SPIGOT AND SOCKET WITH RESILIENT MATERIAL TO PREVENT ENTRY OF CONCRETE.
  - AFTER INITIAL TESTING, PLACE AND COMPACT MORE CONCRETE ACROSS FULL WIDTH OF TRENCH TO ENCASE PIPE TO 300MM ABOVE CROWN.
- SELECTED FILL MATERIAL:
  - THIS SHOULD CONSIST OF UNIFORM READILY COMPACTIBLE MATERIAL, FREE FROM TREE ROOTS, VEGETABLE MATTER, BUILDING RUBBISH AND FROZEN SOIL.
  - WHEN USED AS FILL THE MATERIAL SHOULD NOT CONTAIN LARGE CLAY LUMPS OR COBBLES.
  - 'AS DUG' MATERIAL MAY BE USED PROVIDED THAT IT IS READILY COMPACTIBLE AND PROVIDES STABLE EMBEDMENT.
- WHERE THE FINAL DEPTH OF COVER TO THE CROWN OF PIPES IS LESS THAN 900MM IN AGRICULTURAL LAND AND PUBLIC OPEN SPACE OR LESS THAN 1200MM IN HIGHWAYS AND PARKING AREAS WITH UNRESTRICTED ACCESS FOR HGV's (VEHICLES WITH A GROSS VEHICLE WEIGHT IN EXCESS OF 7.5 TONNES), THEY ARE TO HAVE A CONCRETE BED AND SURROUND AND MAY NEED ADDED PROTECTION VIA A REINFORCED CONCRETE SLAB. THE DEPTH OF COVER TO THE CROWN OF PIPES CAN BE REDUCED FOR THE FOLLOWING AREAS ONLY:
  - DOMESTIC GARDENS AND PATHWAYS WITHOUT ANY POSSIBILITY OF VEHICULAR ACCESS – 350MM.
  - DOMESTIC DRIVEWAYS, PARKING AREAS AND YARDS WITH HEIGHT RESTRICTIONS TO PREVENT ENTRY BY HGV's – 500MM.
  - DOMESTIC DRIVEWAYS, PARKING AREAS AND NARROW STREETS WITHOUT FOOTWAYS (EG. NEWS DEVELOPMENTS) WITH LIMITED ACCESS FOR HGV's) – 900MM.
- PIPE MATERIAL AND STRENGTH:
  - ALL SEWER PIPES UP TO AND INCLUDING 225MM DIAMETER ARE TO BE VITRIFIED CLAY COMPLYING WITH BS 65 (STORM SEWERS) & BS EN 295 (FOUL SEWERS).
  - ALL SEWER PIPES 300MM DIAMETER AND ABOVE TO BE CLASS M CONCRETE PIPES UNLESS NOTED OTHERWISE.
  - UNPLASTICISED PVC PIPES, JOINTS AND FITTINGS FOR GRAVITY SEWERS, WHERE AGREED AS AN ALTERNATIVE TO CLAY OR CONCRETE, SHALL COMPLY WITH THE RELEVANT PROVISIONS OF BS 4660 AND BS EN 1401-1, TO BE LAID IN MAXIMUM 3M LENGTHS.
  - THERMOPLASTICS STRUCTURED WALL PIPES, WHERE AGREED AS AN ALTERNATIVE TO CLAY OR CONCRETE, SHALL COMPLY WITH THE RELEVANT PROVISIONS OF THE W1'S 4-35-01.
- A FLEXIBLE MECHANICAL JOINT SHALL BE PROVIDED IN EACH SECTION OF THE PIPELINE AND WITHIN 150MM OF WHERE IT ENTERS A BUILDING OR CONNECTS WITH A WALL OR OTHER STRUCTURE.

ACCESS CHAMBERS:

- ALL POLYPROPYLENE INSPECTION CHAMBERS TO BE OSMa WAVIN (OR SIMILAR APPROVED) AND INSTALLED IN ACCORDANCE WITH MANUFACTURER'S INSTRUCTIONS.
- ALL REINFORCED PRECAST CONCRETE SHAFTS, CHAMBERS, COVER SLABS, LANDING SLABS, AND SEATING RINGS TO BE BY CPM (OR SIMILAR APPROVED).
- ALL BRICKWORK SHALL BE CLASS B ENGINEERING, LAID ON CLASS (i) MORTAR IN ENGLISH BOND.
- CHAMBERS SHALL BE BACKFILLED WITH DOT TYPE 1 SUB-BASE.
- UNLESS OTHERWISE STATED, ALL MANHOLES AND CHAMBERS SHALL BE CONSTRUCTED IN ACCORDANCE WITH SEWERS FOR ADOPTION 7th EDITION (PUBLISHED BY THE WATER SERVICES ASSOCIATION, AUG 2012).
- THE FIRST MANHOLE UPSTREAM FROM THE CONNECTION TO THE PUBLIC SEWER SHOULD, WHEN CONSTRUCTED, BE FITTED WITH A SCREEN IN ORDER TO PREVENT DEBRIS ENTERING THE PUBLIC SEWER. THE SCREEN SHOULD NOT BE REMOVED UNTIL IMMEDIATELY PRIOR TO THE OCCUPATION OF PREMISES TO BE SERVED BY THE SEWER.
- MANHOLE COVER GRADES LOCATED IN:
  - CARRIAGEWAY OF ROADS (INCL. PARKING AREAS); CLASS D400
  - FOOTPATHS, PAVED AREAS & DOMESTIC PARKING; CLASS B125
  - ALL FRAME DEPTHS TO BE 150MM MINIMUM, EXCEPT FOR RESIDENTIAL CUL-DE-SACS WHERE 100MM IS ACCEPTABLE. MINIMUM CLEAR OPENING = 600MM X 600MM FOR PRIVATE DRAINAGE.
- COVER LEVELS GIVEN TO CHAMBERS ARE TO BE ADJUSTED TO SUIT FINAL FINISHED SITE LEVELS.
- WHERE COVERS LOCATED WITHIN PAVED AREAS TO BE RECESSED (IF DIRECTED BY LANDSCAPE ARCHITECT), ALLOW PETER SAVAGE 'SHILTON' KITEMARKED RANGE KS30 OR SIMILAR APPROVED WHERE B125 / D400 COVERS ARE REQUIRED.
- WHERE INTERNAL CHAMBERS (WITHIN THE BUILDING) ARE REQUIRED, THEY ARE TO HAVE MECHANICALLY FIXED AIRTIGHT COVERS. THESE MAY BE RECESSED TO SUIT THE ARCHITECTS REQUIREMENTS FOR FINISHES, EG PETER SAVAGE R2T-450.

ALL DIMENSIONS IN MILLIMETRES (mm) UNLESS NOTED OTHERWISE. ALL LEVELS ARE IN METRES (m) ABOVE ORDINANCE DATUM. THIS DRAWING SHOULD BE READ IN CONJUNCTION WITH THE GENERAL ARRANGEMENT DRAWING. DO NOT SCALE FROM THIS DRAWING. IF IN DOUBT, ASK..

Rev.	Date	Details	App'd

PROJECT TITLE:  
SHOTTON COMMUNITY  
CENTRE

DRAWING TITLE:  
PROPOSED DRAINAGE  
DETAIL SHEET 1

CLIENT:  
SHOTTON PARISH  
COUNCIL

STATUS: TENDER

Design: CEM	CAD: CEM
Chk'd: GR	App'd: MD
Date: 05.02.19	Scale: NTS @A1

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Project no:	Drg no:	Rev:
1422	L(-1)106	T

MINIMUM 100MM DIAMETER VENTILATION PIPE WITH COWL TO PREVENT VERMIN ENTRY. TO BE SITED IN A POSITION AGREED WITH CLIENT AND/OR ARCHITECT. NB VENT CAN BE FITTED TO TOP OR SIDE OF TANK.

TANK INSTALLATION AND BACKFILLING TO BE IN ACCORDANCE WITH CRATE MANUFACTURER'S REQUIREMENTS. ALL NECESSARY CLIPS AND CONNECTORS ARE TO BE PLACED WHEN THE TANK IS ASSEMBLED. THE TANK WILL REQUIRE VENTING - REFER TO TANK MANUFACTURER'S STANDARD DETAILS FOR APPROPRIATE METHOD.

SITE SPECIFIC STRUCTURAL CALCULATIONS ARE TO BE UNDERTAKEN IN LINE WITH CIRIA C680/C737 ALLOWING FOR FINAL INSTALLED ENVIRONMENT (IE LANDSCAPED AREA THAT MAY BE USED FOR RIDE ON MOWERS, ALLOW 5/5 LOADING TO DIN1072 CLASSIFICATION). CONTRACTOR TO ASSESS USAGE OF THE AREA FOR THEIR REQUIREMENTS AND ENSURE THAT THE TANK IS NOT COMPROMISED AS A RESULT OF PLANT MOVEMENT, MATERIAL STORAGE OR ANY OTHER ONEROUS LOADING.

TANK BASE AND SURROUND TO SUIT TANK MANUFACTURER'S REQUIREMENTS, TYPICALLY ALLOW MINIMUM 100MM THK COARSE SAND OR NON ANGULAR AGGREGATE (PIPE BEDDING) MATERIAL.

TANK TO BE WRAPPED IN A GEO-MEMBRANE IN ACCORDANCE WITH TANK MANUFACTURER'S REQUIREMENTS. ALLOW 1.0MM THICKNESS (EG VISQUEEN UDG) WITHIN PROTECTIVE GEOTEXTILE FLEECE (300g/m<sup>2</sup>). PROVIDE PROTECTION BOARDS TO SIDES AND TOP WITH PROTECTION PIECES TO CORNERS PRIOR TO BACKFILL AS REQUIRED BY MEMBRANE INSTALLATION LITERATURE. GEOMEMBRANE TO BE EITHER SITE WELDED OR PROVIDED AS A FACTORY PRE-WELDED SHOE BOX. SITE FIXED MEMBRANE WITH TAPED JOINTS IS NOT CONSIDERED TO BE ACCEPTABLE.

BACKFILL TO SUIT TANK MANUFACTURER'S REQUIREMENTS, TYPICALLY ALLOW CLEAN GRANULAR MATERIAL (CLASS 6N OR 6P) PLACED IN CONTROLLED COMPACTED LAYERS AS CLAUSE 610 OF SHW.

EXCAVATION FOR TANK TO BE BATTERED OR BENCHED TO ACHIEVE EFFECTIVE ANGLE OF 45DEGREES OR GREATER FROM VERTICAL.


IN/OUTFLOW

PROVIDE INLET, OUTLET AND VENT PIPE CONNECTIONS AT PRE-FORMED SOCKET POINTS OR OTHERWISE USE A 'TOP-HAT' FLANGE ADAPTOR

2LAYER TANK SYSTEM, EACH LAYER 400MM DP, OVERALL TANK 800MM DEEP (BASED ON WAVIN AQUACELL UNITS OR SIMILAR, EACH AQUACELL UNIT IS 1.0M X 0.5M X 0.4M. OTHER CELLULAR SYSTEMS ARE AVAILABLE AND SOME HAVE DIFFERENT HEIGHTS WHICH MAY AFFECT THE HEAD/FLOW RELATIONSHIP OF THE DRAINAGE SYSTEM AND SO PROPOSALS WITH DIFFERENT SIZES MUST BE ASSESSED BOTH HYDRAULICALLY AND STRUCTURALLY. THE PLAN AREA OF THE TANK WILL VARY WITH DIFFERENT TANK HEIGHTS. NOTE SOME SYSTEMS DO NOT ALLOW LATERAL INFLOW TO THE TANK UNITS IN WHICH CASE A SUPPLEMENTARY DISTRIBUTION PIPE ARRANGEMENT IS REQUIRED)

SIMILAR CONSTRUCTION TO BE USED FOR MAIN NEW CAR PARKING AREA (ACCESSWAY AND AISLES), EXCEPT SUB-BASE TO BE CONSTANT THICKNESS AS BOTH FINISHED GROUND AND FORMATION ARE TO FALL AT 1IN100.

ALL PERVIOUS PAVING UNITS TO BE INSTALLED IN ACCORDANCE WITH MANUFACTURER'S RECOMMENDATIONS AND BS 7533-3, WITH PARTICULAR CARE TAKEN NOT TO COMPROMISE JOINTS (EG BY SOIL FOR SOFT LANDSCAPING, ETC). ALSO SEQUENCING OF CONSTRUCTION WORKS IN TERMS OF PLANT MOVEMENT AND/OR STORAGE OF MATERIALS MUST NOT COMPROMISE THE FORMATION PERMEABILITY OR PAVEMENT INTEGRITY

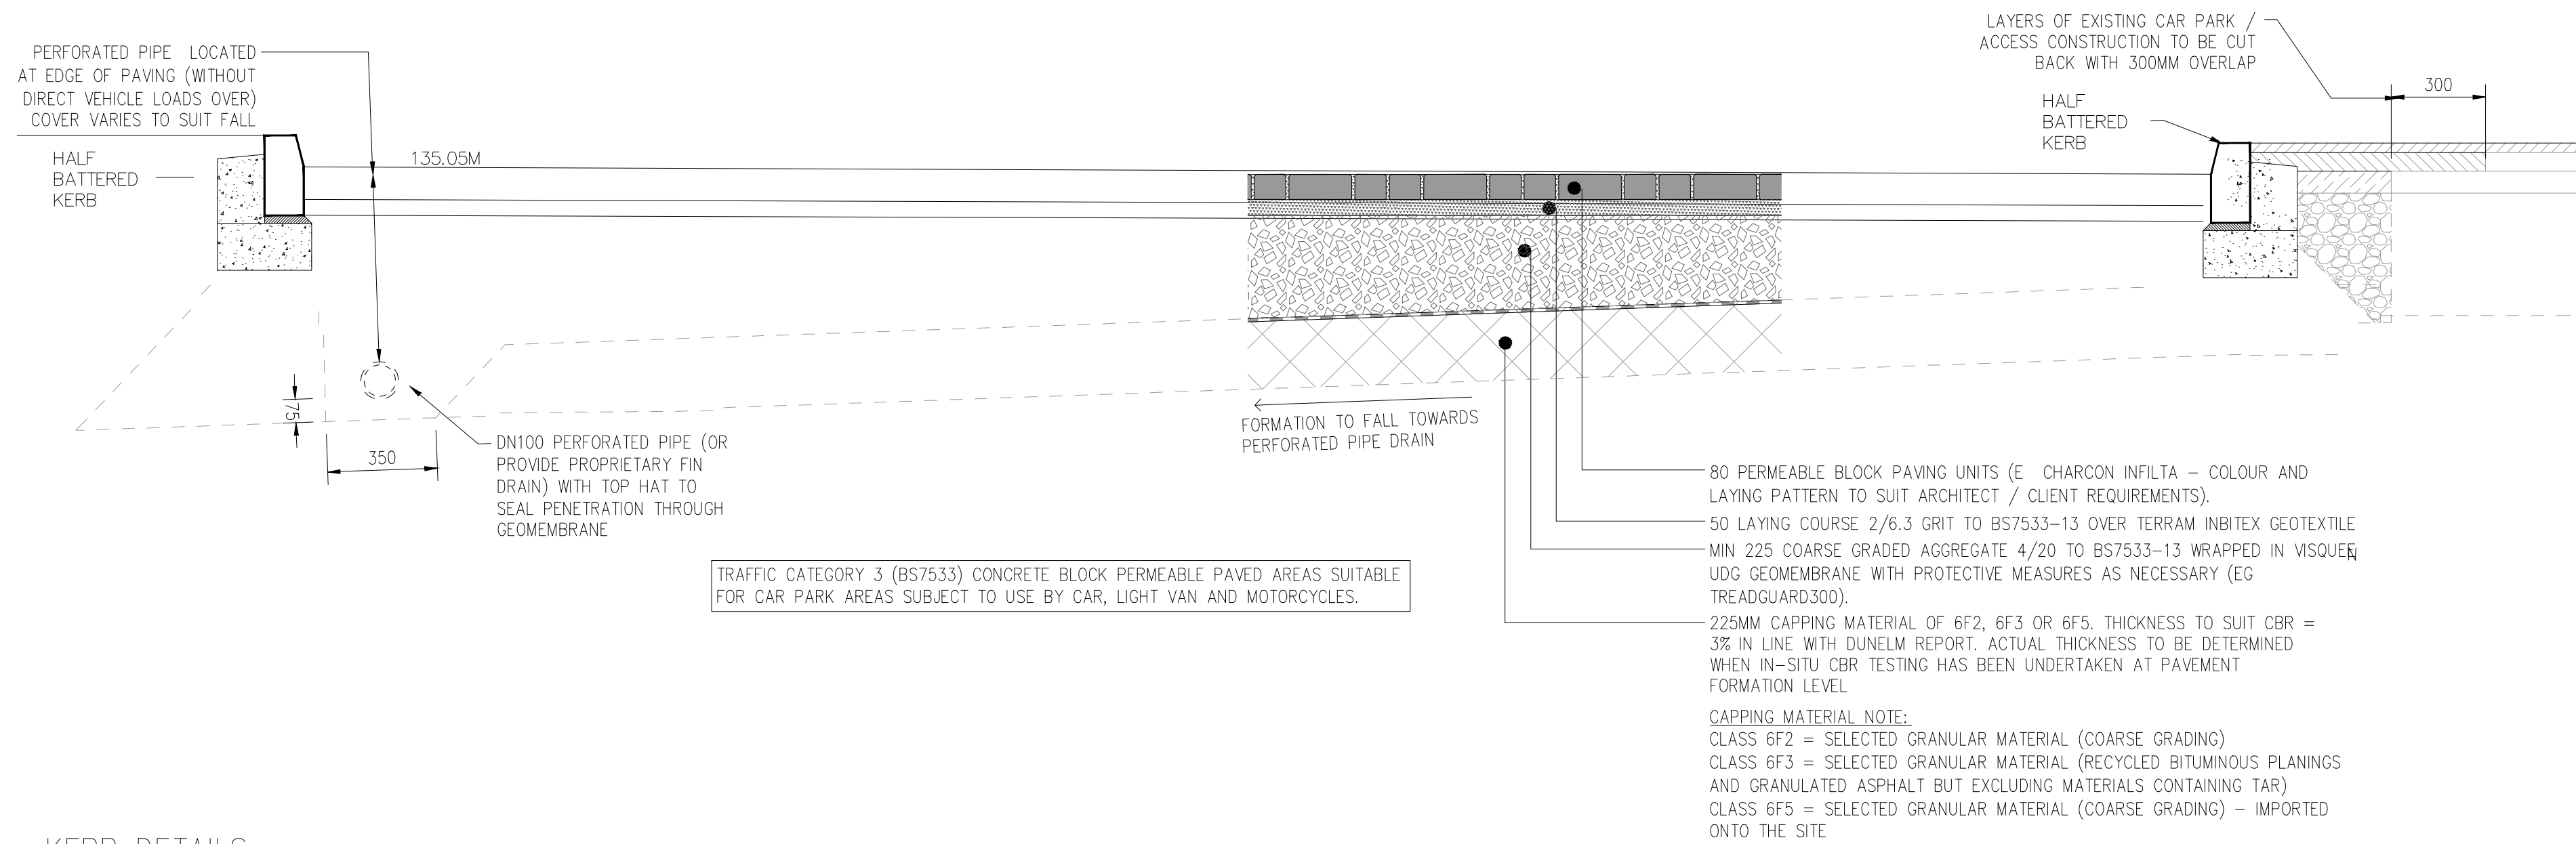[illegible]

150

60

15

100

25

255x125 HALF BATTERED KERB

25MM THK DESIGNATION (i) MORTAR BED

300x150MM FORM AND BACKING IN CONC GRADE ST2

CARRIAGEWAY FINISHED LEVEL

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3. ALL BELOW GROUND DRAINAGE WORKMANSHIP TO BE CARRIED OUT IN STRICT ACCORDANCE WITH BS 8000 'WORKMANSHIP OF BUILDING SITES, PART 14: CODE OF PRACTICE FOR BELOW GROUND DRAINAGE'.
4. EXACT LOCATIONS AND CURRENT USAGE OF ALL EXISTING DRAINAGE TO BE ESTABLISHED ON COMMENCEMENT OF ANY WORKS.
5. ALL NEW BELOW GROUND DRAINAGE WORKS TO BE INSPECTED AND APPROVED BY BUILDING CONTROL PRIOR TO BACKFILLING.

6. REFER TO NOTES ON DRAWING 126B31-101.

7. THE CONTRACTOR SHALL ASCERTAIN THE CBR OF THE SUBGRADE ON SITE IN ORDER TO DETERMINE THE REQUIRED SUB-BASE AND/OR CAPPING THICKNESS(ES).
8. PRIOR TO LAYING ANY MATERIAL THE SUBGRADE MUST BE INSPECTED AND ANY SOFT SPOTS REMOVED AND FILLED WITH TYPE 2 MATERIAL TO SHW CLAUSE 804.
9. ALL ROAD GULLY AND DRAINAGE CHANNEL CONNECTIONS SHALL BE 150MM DIAMETER UNLESS OTHERWISE SPECIFIED.
10. ALL PRE CAST UNITS SHALL BE MANUFACTURED USING SULPHATE RESISTING CEMENT.

Rev.	Date	Details	App

DRAWING TITLE:  
PROPOSED DRAINAGE  
DETAIL SHEET 2



STATUS: TENDER

Design: CEM	CAD: CEM
Chk'd: GR	App'd: MD
Date: 05.02.19	Scale: NTS @A1



Project no:	Drg no:	Rev:
1422	L(-1)107	T



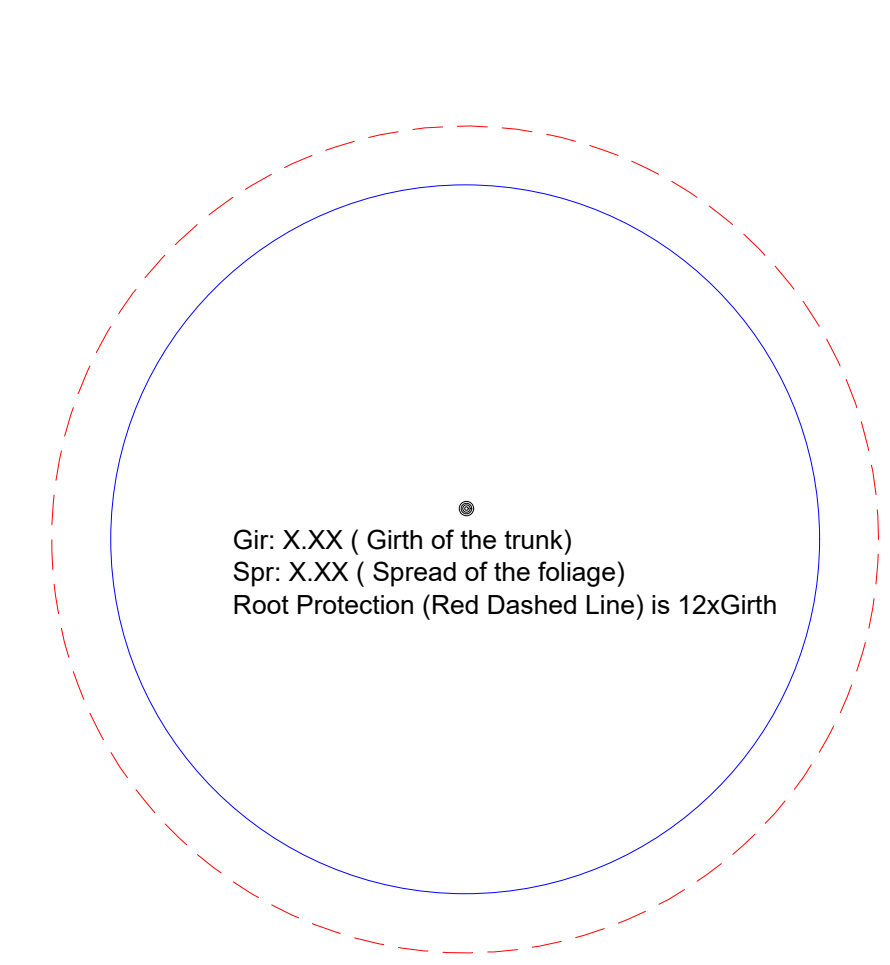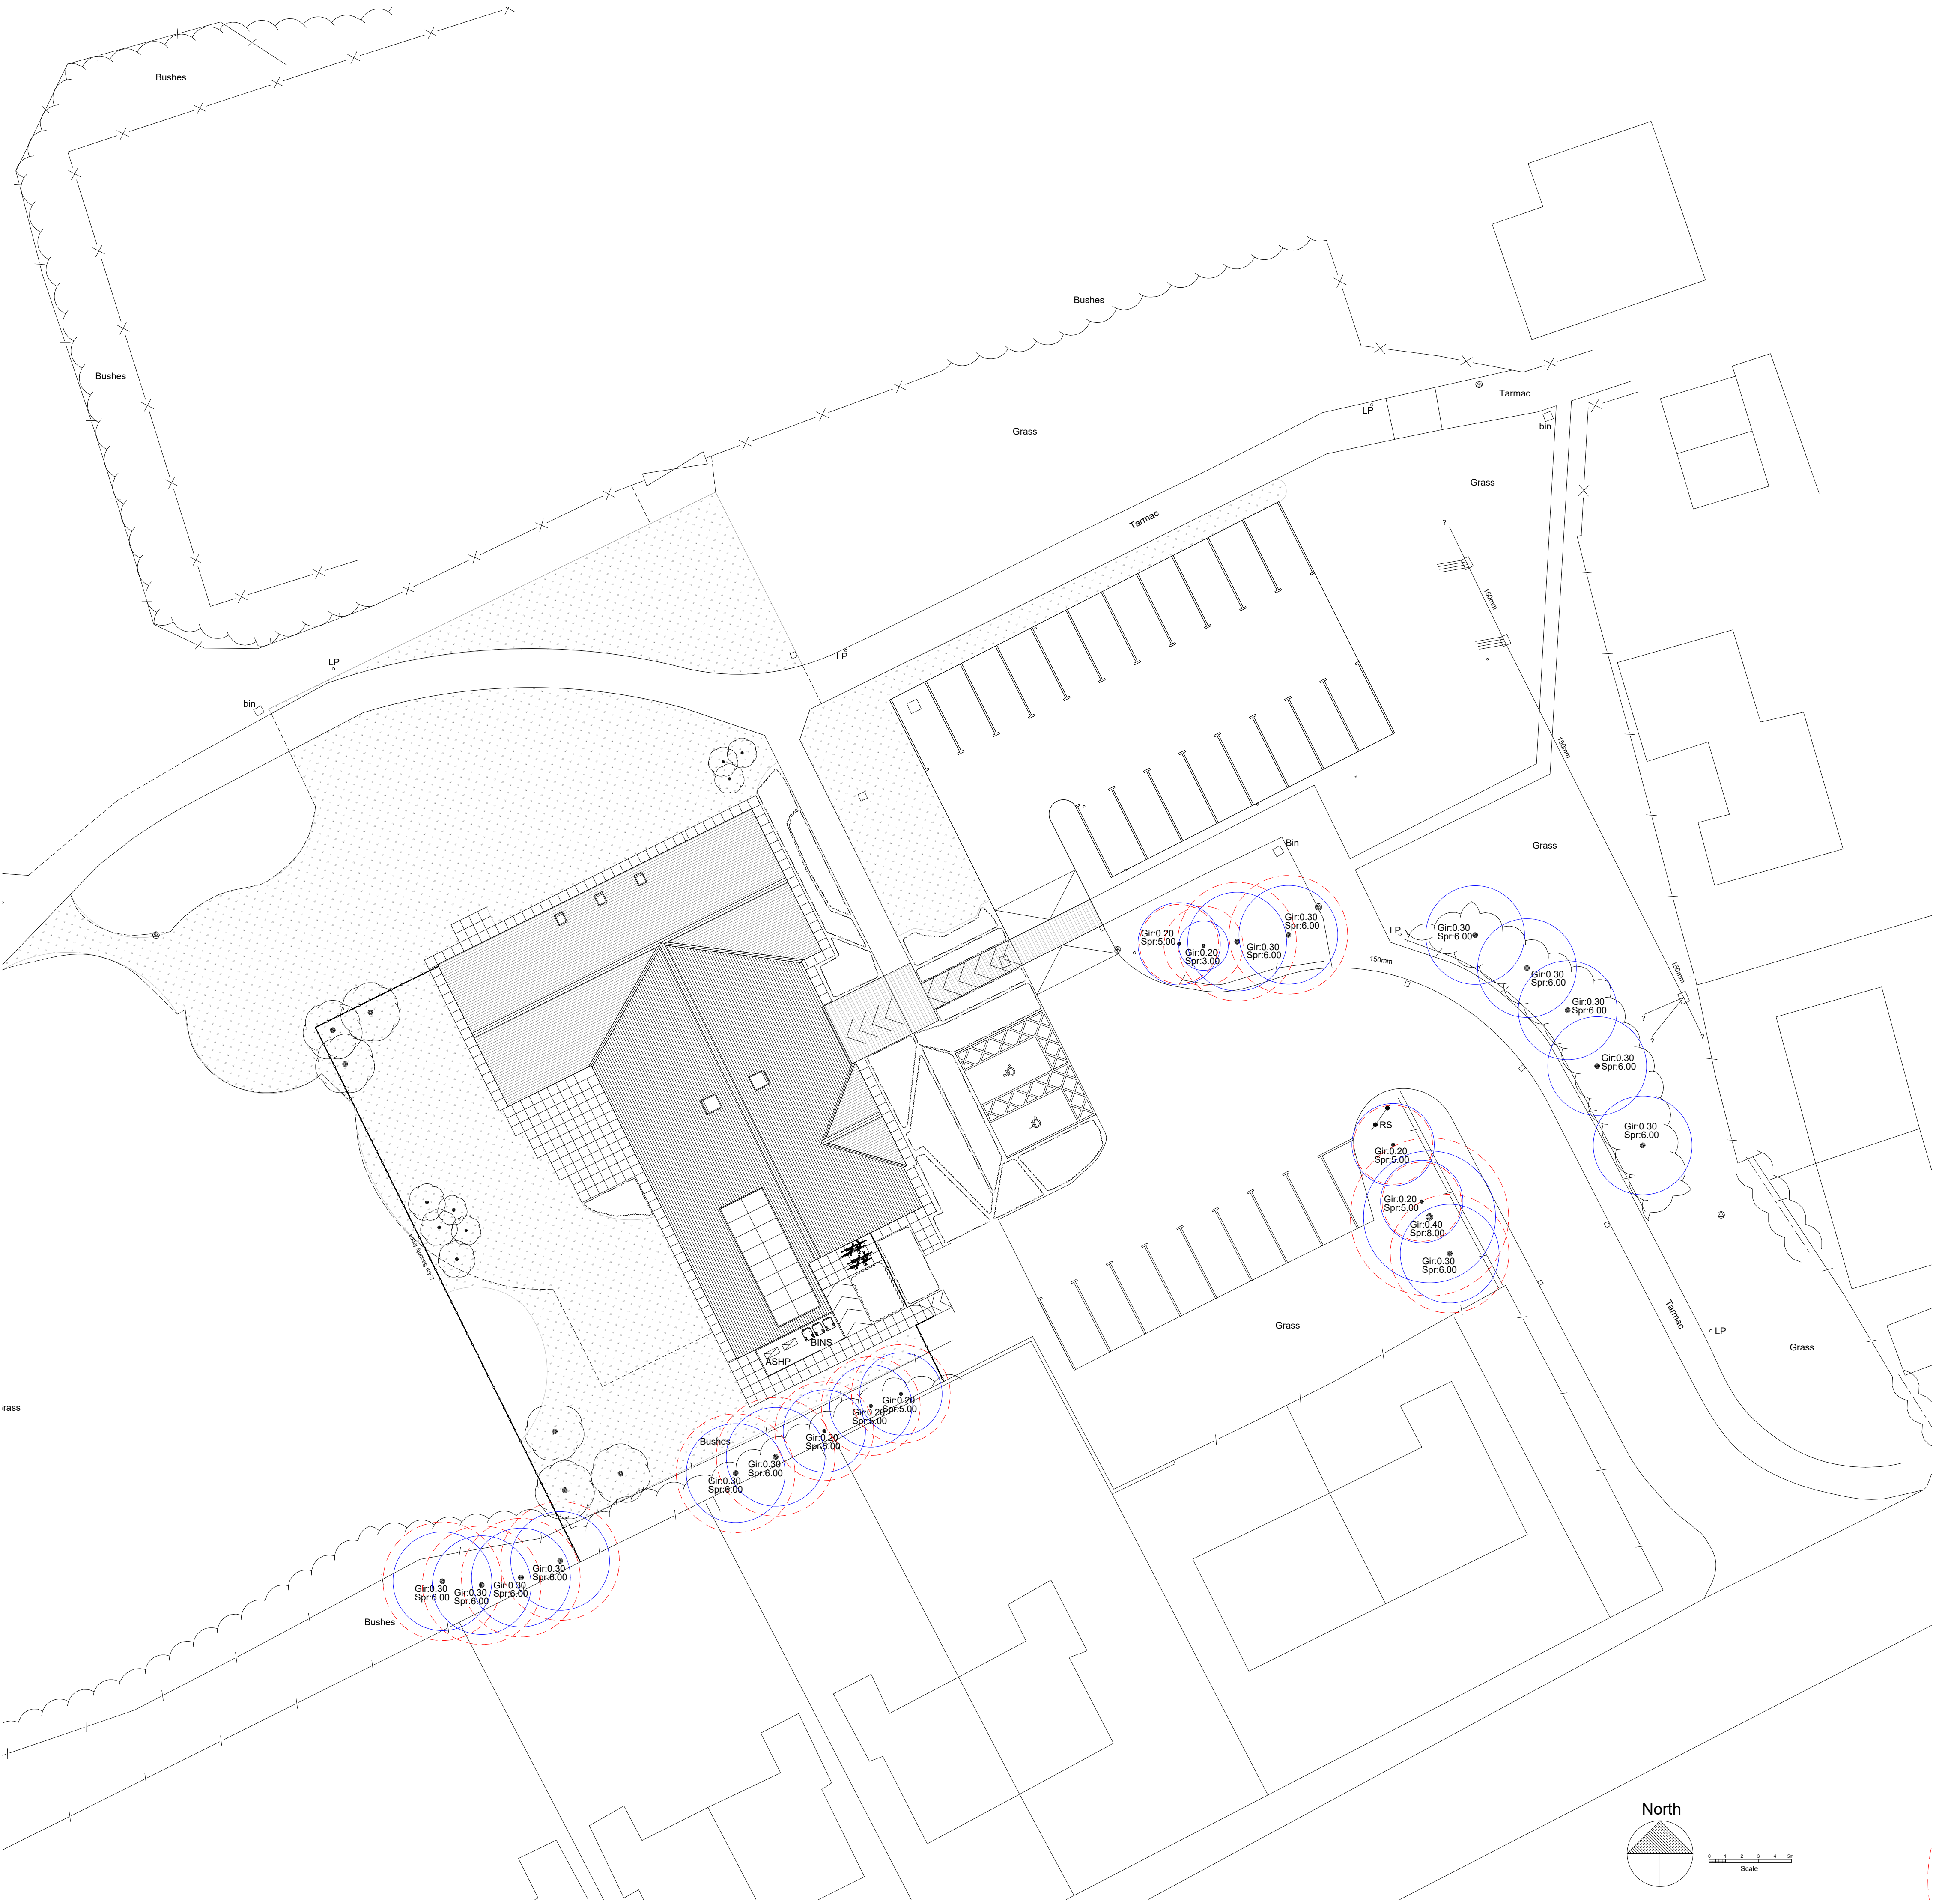

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T	05.02.19	TENDER ISSUE	MD
Rev.	Date	Details	App'd

PROJECT TITLE:

SHOTTON COMMUNITY CENTRE

DRAWING TITLE:

TREE PROTECTION PLAN

CLIENT:

Shotton Parish Council

STATUS: TENDER

Design: SGeo	CAD: WS
Chk'd: MRD	App'd: MRD
Date: 31.01.19	Scale: 1:200 @A1




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Project no:	Drg no:	Rev:
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PROJECT TITLE:

SHOTTON COMMUNITY CENTRE

DRAWING TITLE:

Site Establishment Works

CLIENT:

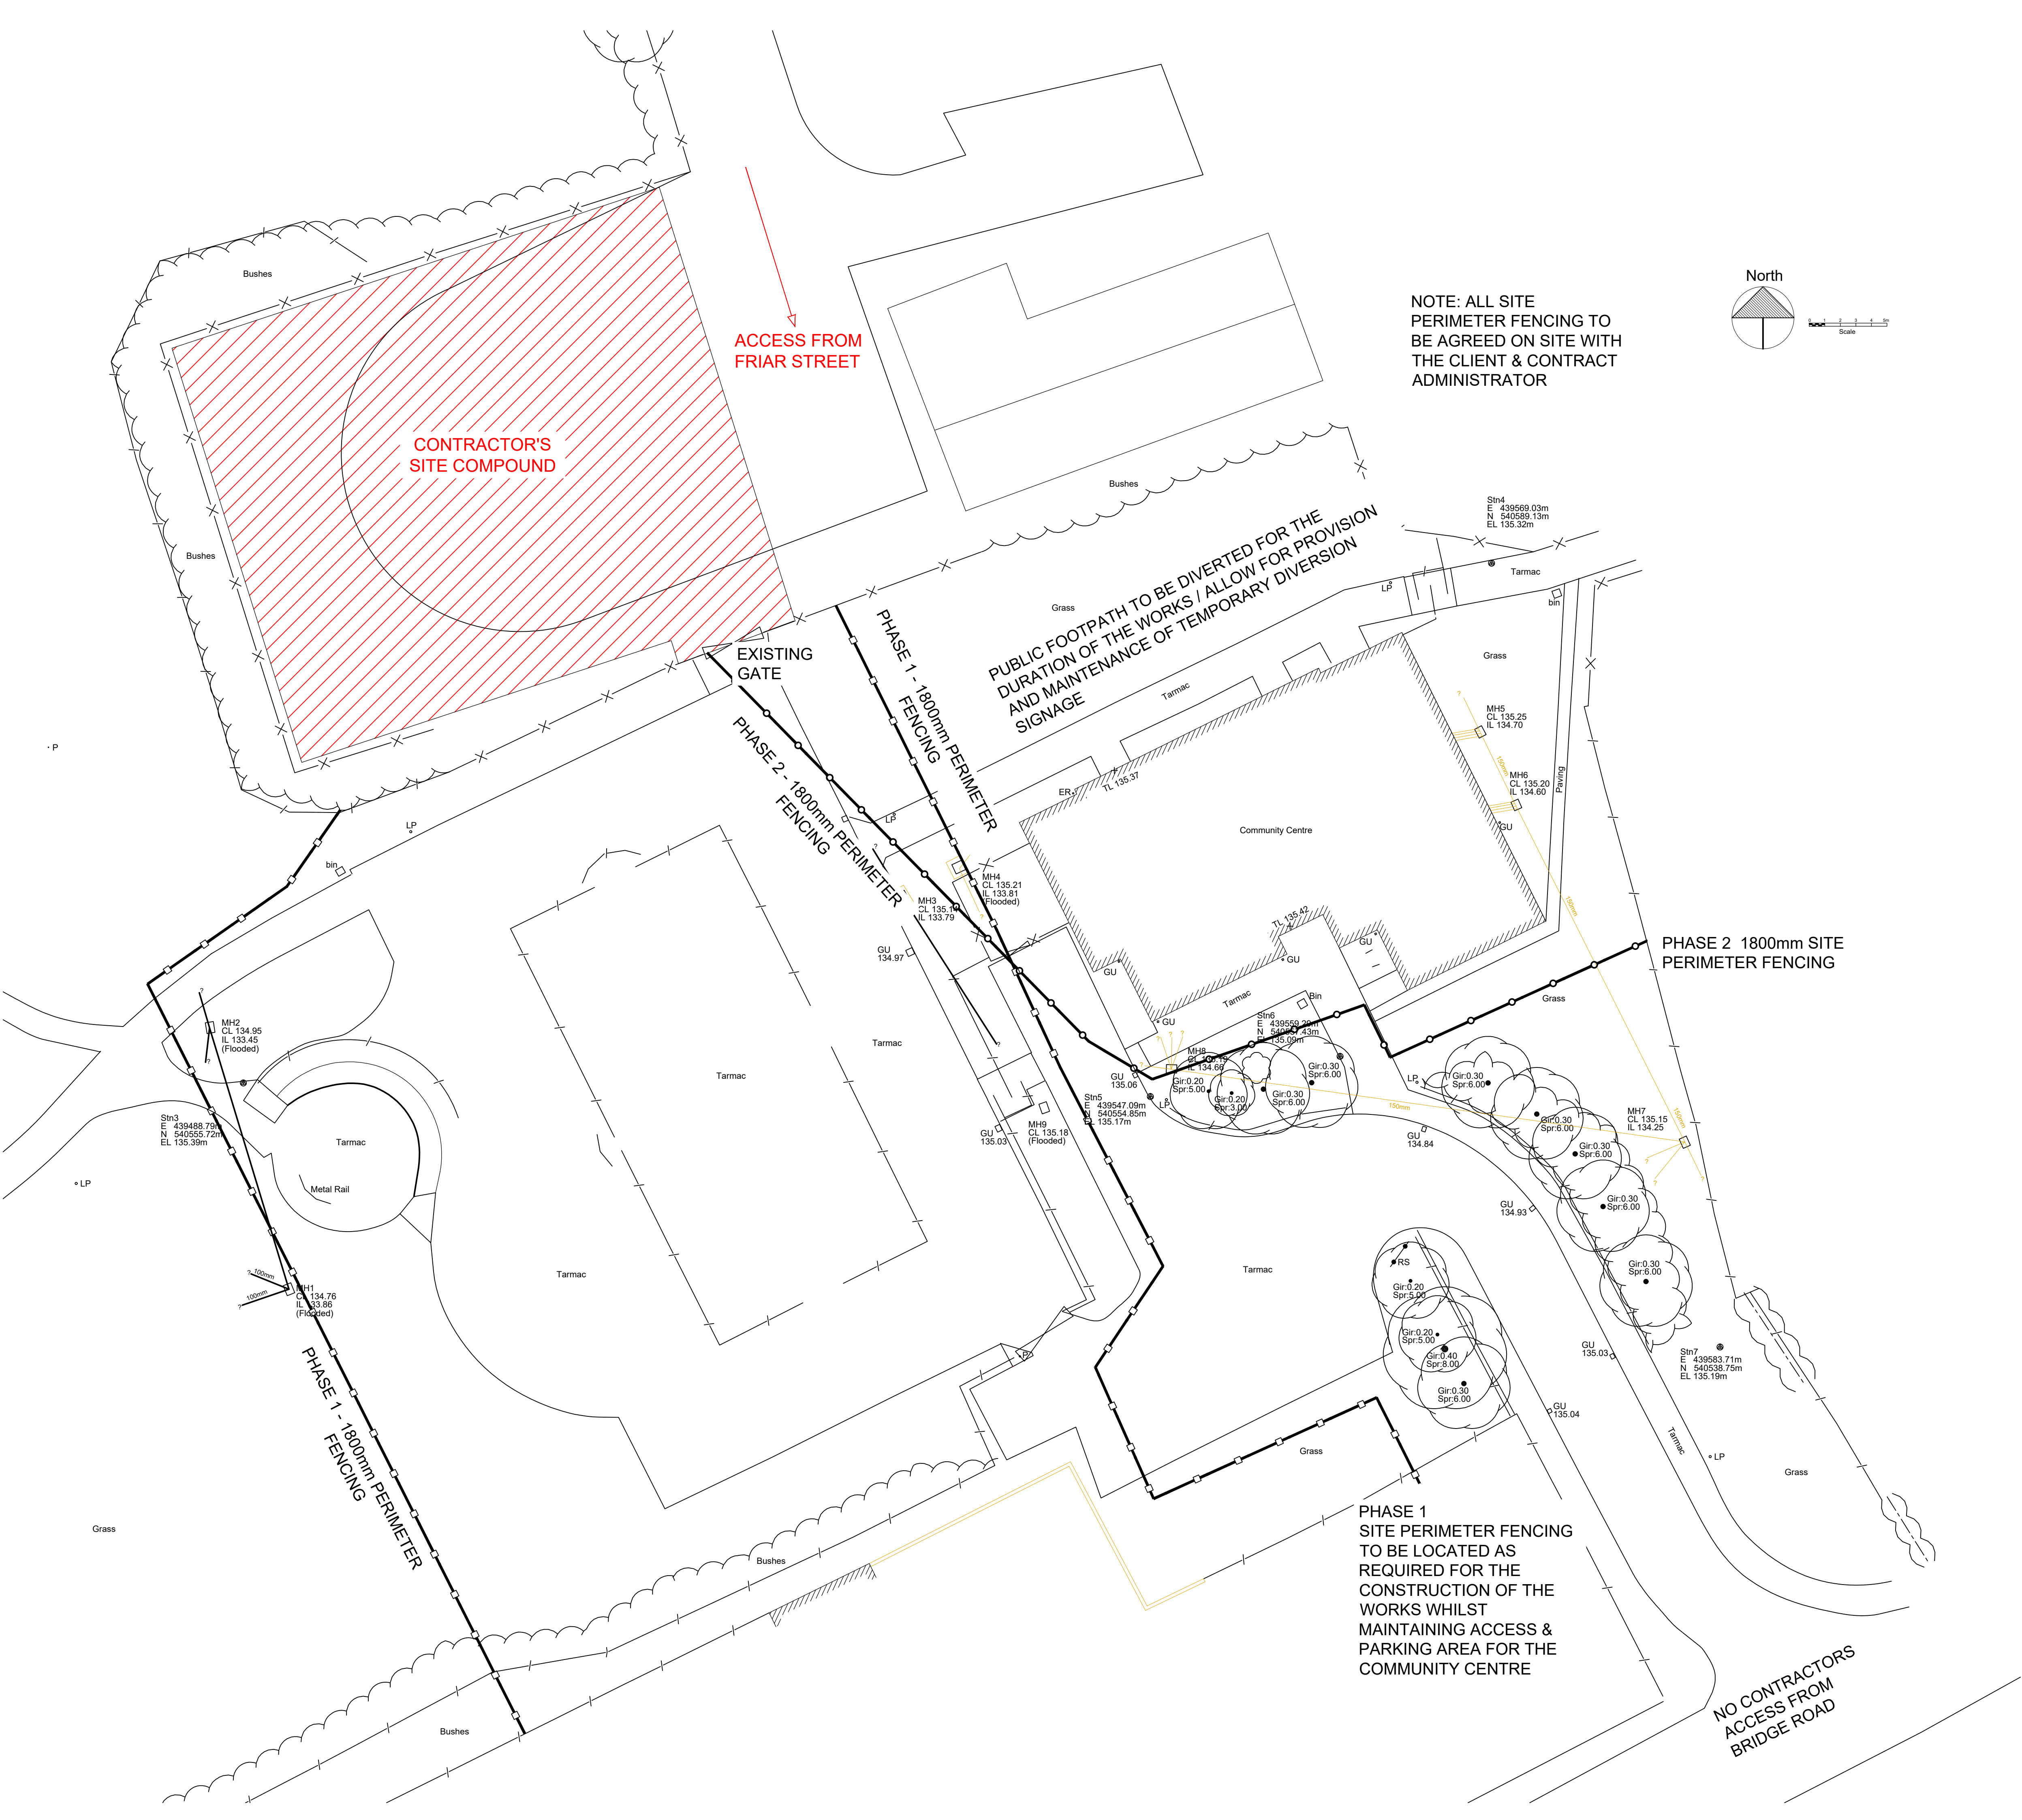Shotton Parish Council

STATUS: TENDER	
Design: SGeo	CAD: WS
Chk'd: MRD	App'd: MRD
Date: 25.07.18	Scale: 1:200 @A1



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Project no:	Drq no:	Rev:
1442	L(90)CDM	T







