



THE INFORMATION ON THESE DRAWING'S ARE FOR BUILDING REGULATIONS APPROVAL ONLY. NOT ALL CONSTRUCTION INFORMATION IS SHOWN. IT IS THE CONTRACTORS RESPONSIBILITY TO ENSURE THAT ALL WORK IS CARRIED OUT IN ACCORDANCE WITH GOOD WORKING PRACTICES & MANUFACTURES INSTRUCTIONS. SHOULD ANY PROBLEMS ARISE ARK IS TO BE CONTACTED IMMEDIATELY.

THIS DRAWING TO BE READ IN CONJUNCTION WITH DRAWINGS AND DETAILS PREPARED BY THE CONSULTANTS, SPECIALIST SUB-CONTRACTORS AND EQUIPMENT SUPPLIERS ENGAGED IN THIS PROJECT. ALL STRUCTURAL TIMBER WORKS TO BE CARRIED OUT FOLLOWING THE GUIDANCE OF THE TRADA TIMBER FRAME CONSTRUCTION MANUAL.

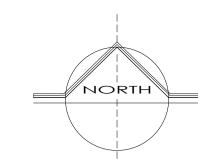

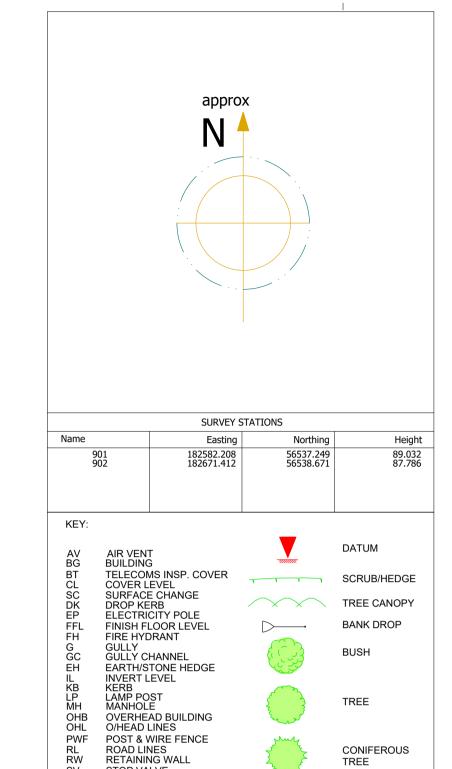

PRIME SURVEYS

SURVEY STN

WALL LEVEL

EAVES POINT FLAT ROOF PT

STOP VALVE TOP OF BANK TRACK LINE

WALL WATER METER

TELEPHONE POLE UTILITY POLE WOODEN FENCE

No. 3, RIVERSIDE NANPEAN, ST AUSTELL CORNWALL, PL26 7YJ tel: 01726 87 81 48

e-mail: primelandsurveys@gmail.com

This drawing is copyright and may not be copied, altered or used for any purposes other than that for which it is issued. ARK grant a licence for the client to copy this drawing for the purpose of this project only (excluding any extension of the project). Do not scale for construction purposes.

Do not scale for construction purposes.

Contractor to check all dimensions on site prior to the commencement of work.

Any discrepancies should be reported to ARK.

All work to be carried out to Local Authority approval.

All work to be carried out in full compliance with current HSE regulations.

All work methods and materials are to comply with relevant British Standards,

approved codes of practice and manufacturer's instructions.© ARK SUSTAINABLE ARCHITECTURE LTD 2023

REVISIONS

REV. DATE DESCRIPTION REV. DATE DESCRIPTION
- 00/00/00 -

ST NEWLYN EAST VILLAGE HALL

PROJECT DESCRIPTION
REFURBISHMENT WORKS

DATE DRAWN
11.12.2023 RC

NEEHAM ROAD, ST NEWLYN EAST, TR8 5LE.

PROPOSED SITE PLAN
(ROOFING WORKS)

SCALE As Noted @A1

DRAWING NO. REV.

TR 01 -

STAGE TENDER SUSTAINABLE ARC

DARBARI UNIT 12, PROW PARK BUSINE
INDUSTRIAL ESTATE, NEWQU

DARBARI UNIT 12, PROW PARK BUSINESS PARK, TRELOGGAN INDUSTRIAL ESTATE, NEWQUAY, TR7 2SX

01637 850144 info@ark-designs.com www.ark-designs.com


THE INFORMATION ON THESE DRAWING'S ARE FOR BUILDING REGULATIONS APPROVAL ONLY. NOT ALL CONSTRUCTION INFORMATION IS SHOWN. IT IS THE CONTRACTORS RESPONSIBILITY TO ENSURE THAT ALL WORK IS CARRIED OUT IN ACCORDANCE WITH GOOD WORKING PRACTICES & MANUFACTURES INSTRUCTIONS. SHOULD ANY PROBLEMS ARISE ARK IS TO BE CONTACTED IMMEDIATELY.


THIS DRAWING TO BE READ IN CONJUNCTION WITH DRAWINGS AND DETAILS PREPARED BY THE CONSULTANTS, SPECIALIST SUB-CONTRACTORS AND EQUIPMENT SUPPLIERS ENGAGED IN THIS PROJECT.

ASBESTOS.

PRIOR TO WORKS COMMENCING ON SITE THE BUILDING OWNER IS TO ARRANGE FOR A TYPE 3 ASBESTOS SURVEY TO BE CARRIED OUT TO ESTABLISH THE PRESENCE OF ASBESTOS. THIS SURVEY WILL HAVE TO BE CARRIED OUT BY A BOHS

P402 APPROVED ASBESTOS SURVEYOR. CONSTRUCTION WORKS CANNOT COMMENCE ON AREAS CONTAINING ASBESTOS UNTIL THE ACM'S ARE REMOVED BY A CONTRACTOR LICENSED BY THE HSE UNDER CONTROLLED CONDITIONS.

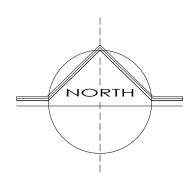

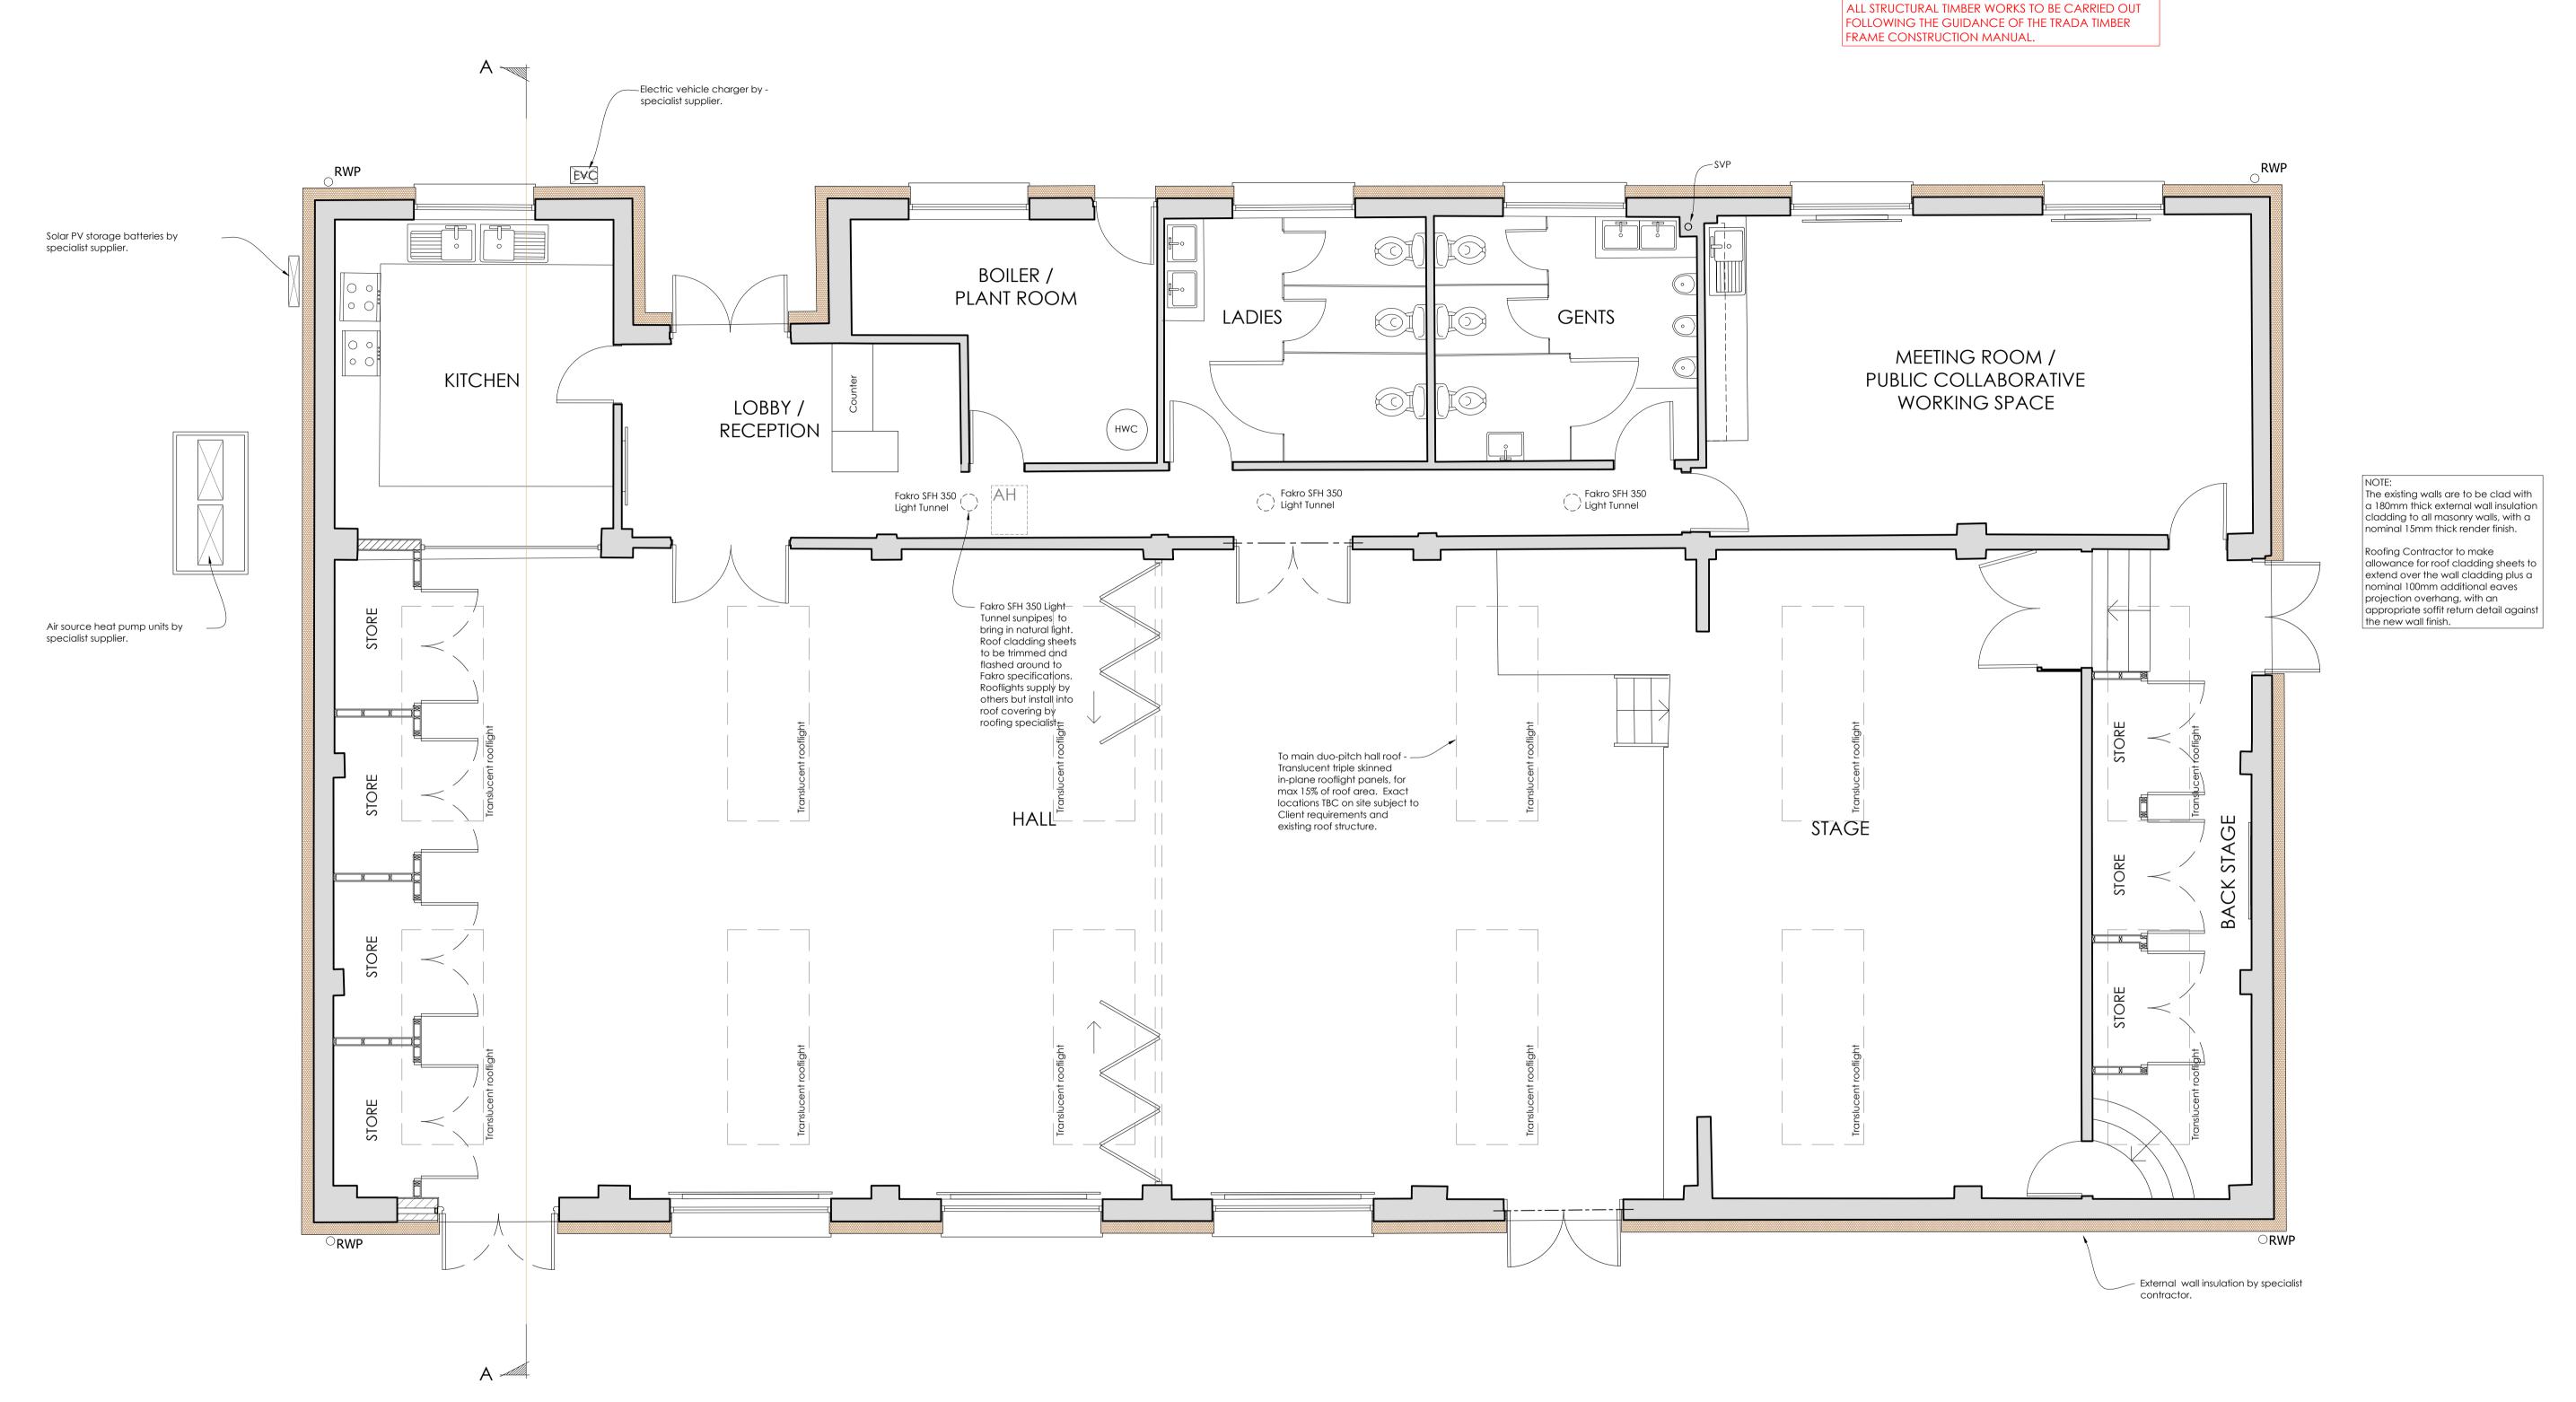

PROPOSED FLOOR PLAN 1:50

This drawing is copyright and may not be copied, altered or used for any purposes other than that for which it is issued. ARK grant a licence for the client to copy this drawing for the purpose of this project only (excluding any extension of the project). Do not scale for construction purposes.

Contractor to check all dimensions on site prior to the commencement of work. Any discrepancies should be reported to ARK.

All work to be carried out to Local Authority approval.

All work to be carried out in full compliance with current HSE regulations. All work methods and materials are to comply with relevant British Standards,

approved codes of practice and manufacturer's instructions. © ARK SUSTAINABLE ARCHITECTURE LTD 2023

REVISIONS

ST NEWLYN EAST VILLAGE HALL

PROJECT DESCRIPTION REFURBISHMENT WORKS DATE DRAWN 11.12.2023 RC

ST NEWLYN EAST, TR8 5LE. DRAWING TITLE PROPOSED FLOOR PLAN (ROOFING WORKS)

NEEHAM ROAD,

SCALE As Noted @A1

TENDER


DARBARI UNIT 12, PROW PARK BUSINESS PARK, TRELOGGAN INDUSTRIAL ESTATE, NEWQUAY, TR7 2SX

THE INFORMATION ON THESE DRAWING'S ARE FOR BUILDING REGULATIONS APPROVAL ONLY, NOT ALL CONSTRUCTION INFORMATION IS SHOWN. IT IS THE CONTRACTORS RESPONSIBILITY TO ENSURE THAT ALL WORK IS CARRIED OUT IN ACCORDANCE WITH GOOD WORKING PRACTICES & MANUFACTURES INSTRUCTIONS. SHOULD ANY PROBLEMS ARISE ARK IS TO BE CONTACTED IMMEDIATELY.


THIS DRAWING TO BE READ IN CONJUNCTION WITH DRAWINGS AND DETAILS PREPARED BY THE CONSULTANTS, SPECIALIST SUB-CONTRACTORS AND EQUIPMENT SUPPLIERS ENGAGED IN THIS PROJECT. ALL STRUCTURAL TIMBER WORKS TO BE CARRIED OUT FOLLOWING THE GUIDANCE OF THE TRADA TIMBER FRAME CONSTRUCTION MANUAL.

ASBESTOS. PRIOR TO WORKS COMMENCING ON SITE THE BUILDING OWNER IS TO ARRANGE FOR A TYPE 3 ASBESTOS SURVEY TO BE CARRIED OUT TO ESTABLISH THE PRESENCE OF ASBESTOS. THIS SURVEY WILL HAVE TO BE CARRIED OUT BY A BOHS P402 APPROVED ASBESTOS SURVEYOR.

CONSTRUCTION WORKS CANNOT COMMENCE ON AREAS CONTAINING ASBESTOS UNTIL THE ACM'S ARE REMOVED BY A CONTRACTOR LICENSED BY THE HSE UNDER CONTROLLED CONDITIONS.

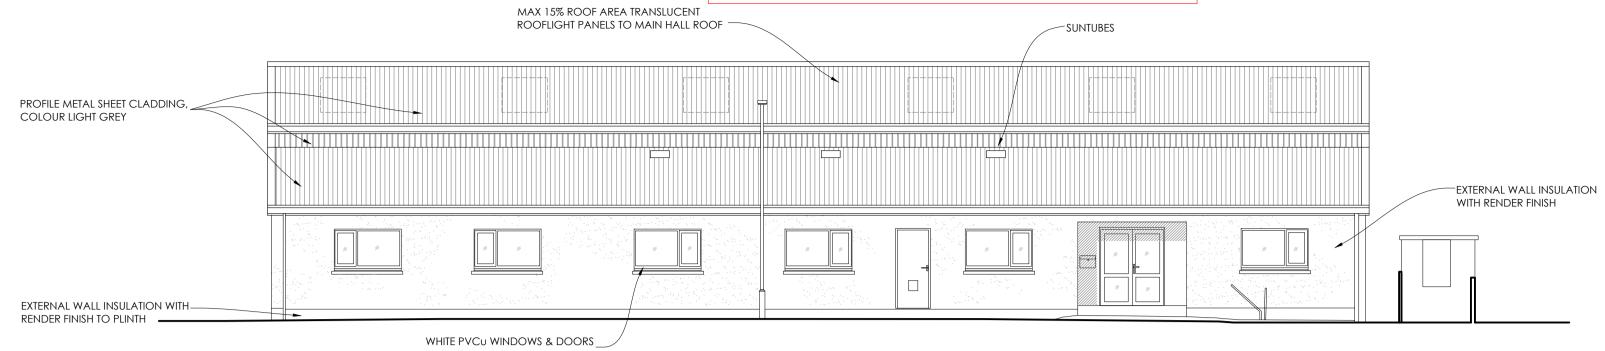


NORTH ELEVATION 1:100

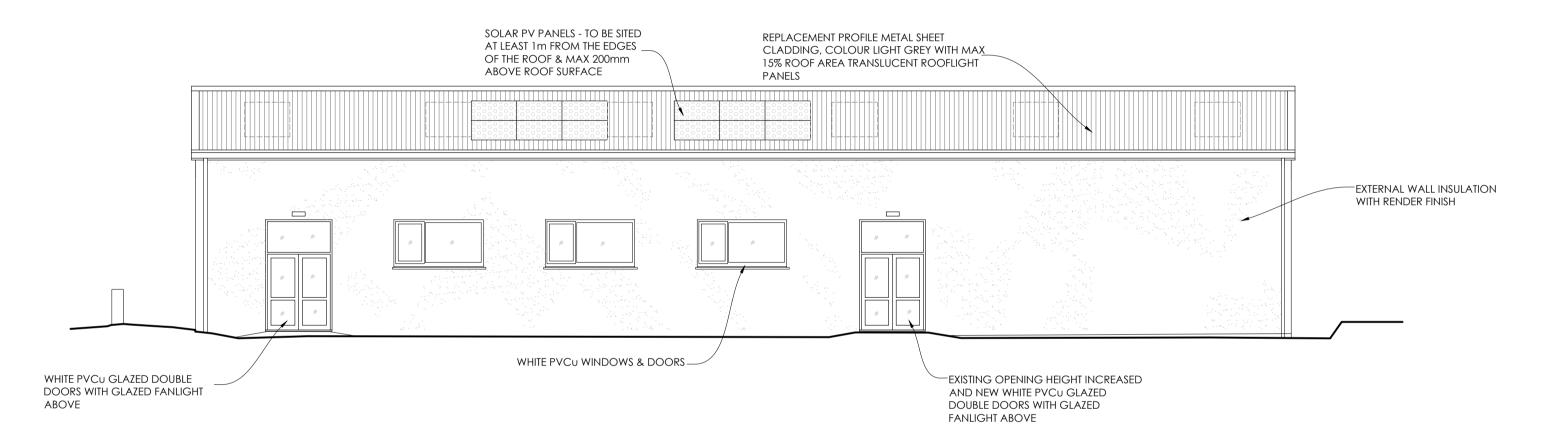

SOUTH ELEVATION 1:100



EAST ELEVATION 1:100

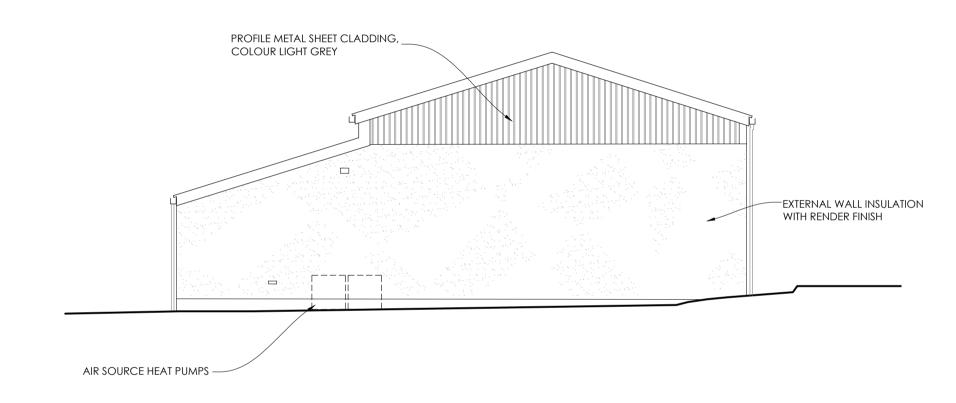


WEST ELEVATION 1:100


Any discrepancies should be reported to ARK.

All work to be carried out to Local Authority approval.

All work to be carried out in full compliance with current HSE regulations. All work methods and materials are to comply with relevant British Standards, approved codes of practice and manufacturer's instructions.

© ARK SUSTAINABLE ARCHITECTURE LTD 2023

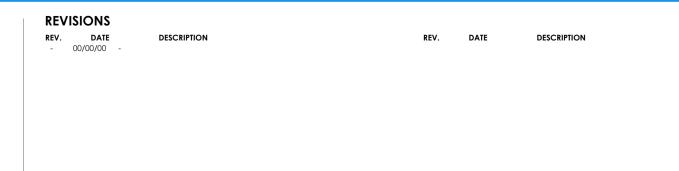

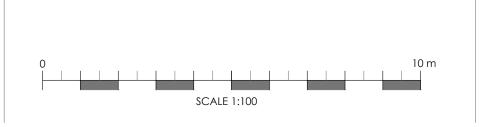



PROJECT DESCRIPTION REFURBISHMENT WORKS

11.12.2023 RC

NEEHAM ROAD, ST NEWLYN EAST, TR8 5LE.

DRAWING TITLE PROPOSED ELEVATIONS (ROOFING WORKS)

SCALE As Noted @A1

TENDER DRAWING NO. REV.

TR 03 -



GENERAL NOTES:

MATERIALS AND WORKMANSHIP:

Building work is to be carried out with adequate & proper materials which are appropriate for the circumstances in which they are used; are adequately mixed or prepared; and which are applied, used or fixed so as adequately to perform the functions for which they are designed: and all in a workmanlike manner. For interpretation of the above refer to the Approved Document Reg 7 Building Regulations 2000.

LIMITING THERMAL BRIDGING & AIR LEAKAGE:

The construction should be carried out to ensure that there are no reasonably avoidable thermal bridges in the insulation layers caused by gaps within the various elements, at the joints between elements, and at the edges of elements.

The Contractor is to obtain a copy of the Accredited Construction Details for Part I published on the planning portal which have been developed to assist the contractor to achieve the performance standards required to demonstrate compliance with the energy efficiency requirements of the Building Regulations.

Additional details are also provided by the Energy Savings Trust known as Enhanced Construction Details which give improved performance beyond the basic requirements.

It is recommended that the Contractor obtains copies of these details and familiarises himself with the techniques to improve construction.

EXISTING EXTERNAL WALLS:

The existing external masonry walls are assumed to be of cavity construction.

The existing walls are to be clad with a proprietary external wall insulation cladding to all masonry walls, with the insulation manufacturer's recommended thin coat render finish. Masonry external walls to achieve a U-value of 0.18W/mK. The wall areas formed by the new vertical metal claddings are also to achieve a U-value of 0.18W/mK.

STEEL ROOF CLADDNG - INCLUDING GABLE WALL PANELS:

Strip off the existing profiled metal roofing sheets, soffit & fascia trims, etc, insulation (if any). Including cladding to gable ends and wall above lean-to roof, and dispose to a suitable licenced recycling/disposal facility.

New built-up roof covering comprising a proprietary system - 0.70mm gauge white liner, bar and bracket insulation void spacer system, mineral wool/glass fibre insulation as per cladding manufacturers specification to achieve 0.16 U-value, new outer sheet in a 32/1000 profile, LG coated - Colour - Goosewing Grey.

To include all seals, flashings, ridge, verge, drip, fascia and soffit trims, colour matched.

Roof to achieve U-value of 0.16W/m²K or better.

Gable walls & wall above lean-to:

Following strip-off new built-up wall comprising a proprietary system - 0.70mm gauge white liner, bar and bracket insulation void spacer system, mineral wool/glass fibre insulation as per cladding manufacturers specification to achieve 0.18 U-value, new outer sheet in a 32/1000 profile, LG coated - Colour - Goosewing Grey.

Strip off existing roof covering back to purlins.

minimum 280mm glass fibre insulation, new outer

sheet in a 32/1000 profile, LG coated - Colour -

To include all seals, flashings, ridge, verge, drip,

With translucent triple skinned in-plane rooflight

panels to cover a maximum of 15% of the roof

New roof cladding to achieve a U-value of

fascia and soffit trims, colour matched.

New built-up roof covering comprising a proprietary system - 0.70mm gauge white liner, bar and bracket insulation void spacer system,

Goosewing Grey.

0.16W/mK.

New plastisol coated steel gutters colour matched to the

New roof covering to extend to

wall insulation and its render

Provide suitable soffit return to

face of new wall cladding's finish

External wall insulation and thin

coat render system to existing

walls by specialist contractor.

100mm beyond face of external

cladding sheets.

To include all seals, flashings, ridge, verge, drip, fascia and soffit trims, colour matched. Wall to achieve U-value of 0.18W/m²K or better.

Solar PV panels - panels to be sited at least 1m

from the edges of the roof, and a maximum of

200mm above the roof surface. Exact number and their location TBC, and to be installed by

specialist supplier.

New plastisol coated steel gutter system including brackets and outlets, colour matched to the cladding sheets, with nominal 100mm dia down pipes to discharge into the existing surface water gullies/disposal system.

Fakro SFH 350 Light Tunnels with either rigid or flexible ductwork sited where indicated on plan. Installed in accordance with manufacturer's instructions. To have a flashing kit to suit the profile of the metal roof cladding sheets, and internal ceiling mounted diffuser.

BUILDING REGULATIONS APPROVAL ONLY, NOT ALL CONSTRUCTION INFORMATION IS SHOWN. IT IS THE CONTRACTORS RESPONSIBILITY TO ENSURE THAT ALL WORK IS CARRIED OUT IN ACCORDANCE WITH GOOD WORKING PRACTICES & MANUFACTURES INSTRUCTIONS. SHOULD ANY PROBLEMS ARISE ARK IS TO BE CONTACTED IMMEDIATELY.

THE INFORMATION ON THESE DRAWING'S ARE FOR

THIS DRAWING TO BE READ IN CONJUNCTION WITH DRAWINGS AND DETAILS PREPARED BY THE CONSULTANTS, SPECIALIST SUB-CONTRACTORS AND EQUIPMENT SUPPLIERS ENGAGED IN THIS PROJECT. ALL STRUCTURAL TIMBER WORKS TO BE CARRIED OUT FOLLOWING THE GUIDANCE OF THE TRADA TIMBER FRAME CONSTRUCTION MANUAL.

CDM 2015 (COMMERCIAL - NOTIFIABLE):

This project involves works where the Client is a Commercial Client and **is notifiable** to the HSE as the construction phase is expected to exceed 500 person days.

Summary of clients role/ duties:

- make suitable arrangements for managing a project, including making sure other Dutyholders are appointed as appropriate, and that sufficient time and resources are allocated to the project.
- make sure that relevant information is prepared and provided to other Dutyholders.
- make sure that the Principal Designer and Principal Contractor carry out their duties. make sure that welfare facilities are provided.

On this project our role as Designer is to secure Building Regulation approval and, accordingly, we have fulfilled our duties

under the CDM 2015 Regulations up to that point. At this stage our role as Principal Designer will cease. All relevant Health and Safety information will be passed to the Client for distribution to the Principal Contractor.

For the construction stage of this project all Designers will have Designer Duties under the CDM Regulations 2015. Designers include any person who as part of their business:

prepares or modifies a design,

• arranges for, or instructs, any person under their control to do so, relating to a structure, or to a product or mechanical or

Design hazard elimination & risk reduction:

The scope of the works are clearly illustrated on our drawings and described in our specification. In the design of this project, we have eliminated as far as reasonably practicable any foreseeable risks. It is considered that there are no significant risks remaining that will not be obvious to a competent Contractor or Designer. Installations involving / requiring hot processes will increase the fire risk and should be avoided.

The works on this project include an internal fit out of an existing building. The landlord/building owner is to provide the building's existing Health and Safety File to the Principal Contractor. This is to include details of all services, any hazards not previously eliminated and any hazardous materials.

Structural collapse

The superstructure design should be carried out in accordance with the relevant temporary works design guidance to ensure stability is maintained

during the construction phase.

The Contractor should carry out a risk assessment in accordance with HSG 168 Fire Safety in Construction, and take actions based on the outcome of this. Also to follow the guidance in STA - 16 Steps to Fire

The Health & Safety at Work Act.

All work related activities associated with this project are subject to the provisions of the Health and Safety at Work Act 1974. The Contractor has a legal obligation to ensure that the Regulations and Act are complied with.

Relative position of Fakro SFH 350 Light Tunnel

At roof penetration use manufacturer's

covering by roofing specialist.

sunpipes in corridor, to be centered on width of

recommended flashing to suit profile of the sheet

Rooflights supply by others but install into roof

Following strip-off new built-up wall comprising a

minimum 280mm glass fibre insulation, new outer

proprietary system - 0.70mm gauge white liner,

bar and bracket insulation void spacer system,

sheet in a 32/1000 profile, LG coated - Colour -

To include all seals, flashings, ridge, verge, drip,

corridor.

metal roof covering.

KITCHEN

fascia and soffit trims, colour matched.

Matching construction for gable walls.

New wall cladding to achieve a U-value of

Goosewing Grey.

Prior to works commencing on site the building owner is to arrange for a Type 3 Asbestos Survey to be carried out to establish the presence of Asbestos.

This survey will have to be carried out by a BOHS P402 approved Asbestos Surveyor. Construction works cannot commence on areas containing asbestos until the ACM's are removed by a Contractor licensed

by the HSE under controlled conditions.

PRIOR TO WORKS COMMENCING ON SITE THE BUILDING OWNER IS TO ARRANGE FOR A TYPE 3 ASBESTOS SURVEY TO BE CARRIED OUT TO ESTABLISH THE PRESENCE OF ASBESTOS. THIS SURVEY WILL HAVE TO BE CARRIED OUT BY A BOHS P402 APPROVED ASBESTOS SURVEYOR. CONSTRUCTION WORKS CANNOT COMMENCE ON AREAS CONTAINING ASBESTOS UNTIL THE ACM'S ARE REMOVED BY A CONTRACTOR LICENSED BY THE HSE UNDER CONTROLLED CONDITIONS.

Strip off existing roof covering back to purlins/structure. New built-up roof covering comprising a

proprietary system - 0.70mm gauge white liner, bar and bracket indulation void spacer system, minimum 280mm glass fibre insulation, new outer sheet in a 32/1000 profile, LG coated - Colour -Goosewing Grey.

To include all seals, flashings, ridge, verge, drip, fascia and soffit trims, colour matched. New roof cladding to achieve a U-value of 0.16W/mK.

> New roof covering to extend to 100mm beyond face of external wall insulation and its render finish. Provide suitable soffit return to face of new wall cladding's finish.

The existing walls are to be clad with a 180mm thick external wall insulation cladding to all masonry walls, with a nominal 15mm thick render finish - roof cladding installation to make allowance for this as noted elsewhere.

SECTION A-A 1:25

Specialist roof cladding

the new roof covering.

HALL

contractor to confirm suitability

of existing steel frame structure

to accommodate loadings of

This drawing is copyright and may not be copied, altered or used for any purposes other than that for which it is issued. ARK grant a licence for the client to copy this drawing for the purpose of this project only (excluding any extension of the project). Do not scale for construction purposes. Contractor to check all dimensions on site prior to the commencement of work. Any discrepancies should be reported to ARK. All work to be carried out to Local Authority approval. All work to be carried out in full compliance with current HSE regulations. All work methods and materials are to comply with relevant British Standards, approved codes of practice and manufacturer's instructions.

ARK SUSTAINABLE ARCHITECTURE LTD 2023

REVISIONS DESCRIPTION

ST NEWLYN EAST VILLAGE HALL PROJECT DESCRIPTION **REFURBISHMENT WORKS**

11.12.2023 RC

NEEHAM ROAD, ST NEWLYN EAST, TR8 5LE. DRAWING TITLE

SECTION A-A (ROOFING WORKS) As Noted @A1

TR 04 -

TENDER DRAWING NO. REV. DARBARI LINIT 12 PROW PARK BUSINESS PARK TRELOGGAN

01637 850144 info@ark-designs.com www.ark-designs.com