

Proposed Roof Plan (Scale 1:50)



Marley Birkdale Fibre Cement Slate, Hook Fixed with 150mm head lap, profile to be suitable for specified

on proprietary licensed manufacturer's prefabricated trussed rafters at pitches as indicated on drawings and max. 600mm centres to B.S. 5268 Part 3. Trussed rafter roof to be fully braced with 100mm x 25mm s.w. bracing, twice nailed to each truss with 3.35mm (10 gauge) x 65mm long galvanised round wire nails, in accordance with roof design by Specialist and LABC requirements. Bracing shown on roof layouts suits the

Any variation in truss profiles, node positions or truss layouts may necessitate alternative bracing requirements to be provided by the relevant roof design Specialist to the satisfaction of the LABC. Lateral restraint to gable walls to be provided at rafter and ceiling tie level with 30mm x 5mm stainless steel tension

Wallplates to be integral part of the timber frame. Anchor straps to be spaced at max. 1200mm centres and

Permanent ventilation to be provided at both eaves equivalent to a continuous 10mm gap incorporating

truss profiles, node position and truss layouts shown on drawings supplied by specialist roof truss

turned down min. 100mm into wall cavity and screw-fixed to masonry with at least one positioned

line of roof a min. 50mm air-space must be maintained above insulation to achieve adequate cross - ventilation all in accordance with Robust Detail 3.03.

self-draining falls to outlets connected to 69mm Dia. circular downpipes fixed to wall surface and connected to the below ground storm drains in accordance with the manufacturers printed instructions and Approved Document Part H. All gutters to be adequately supported and fitted with stop-ends.

RAINWATER GOODS uPVC 100mm Dia. half-round gutters fixed directly to fascia. Gutters to be laid to


straps fixed to min. 3 No. trusses at each gable and

to be min 1000mm long,

within 150mm of bottom end of strap.

fly screens. Where ceiling soffit follows pitch

pitch as defined by manufacturer. Slate fixing hooks to be suitable for a marine environment. Slates fixed to treated 50mm x 25mm s.w. battens on breathable felt underlay (or similar approved), laid to fall to gutters

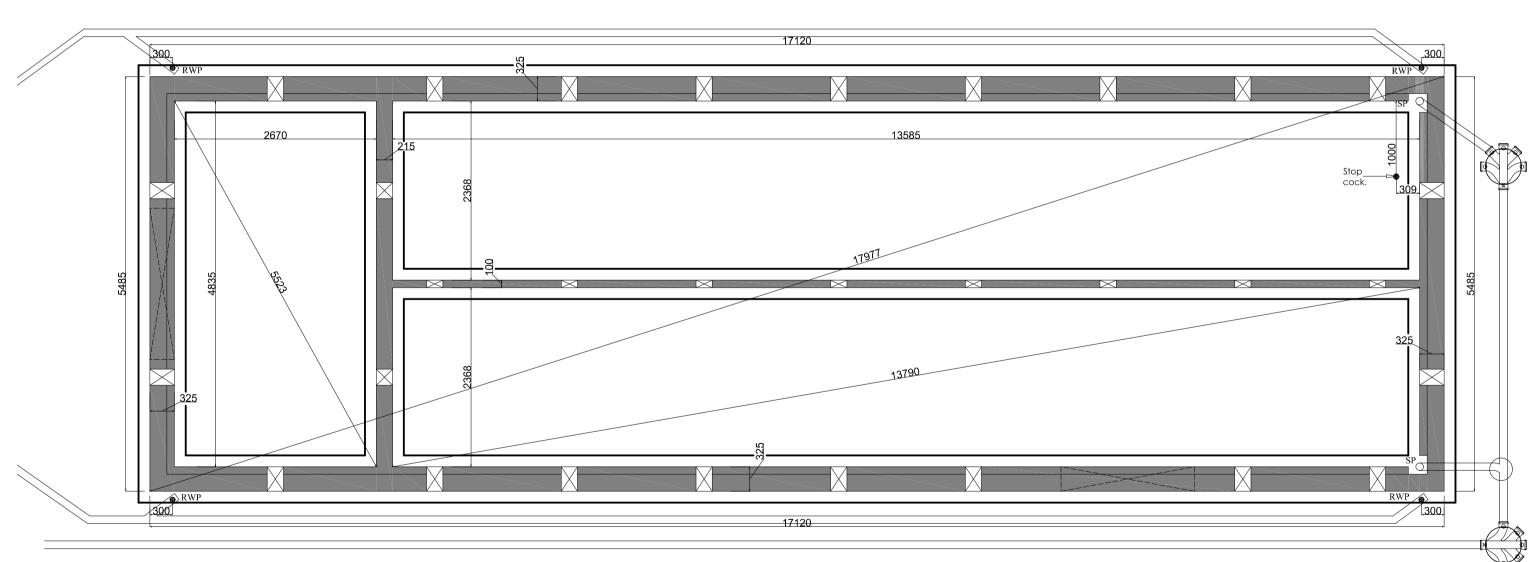

Proposed Sub-Structure Plan (Scale 1:50)

KEY:

Revision	Date	Revision Deta il s		
Rev. A		-	Bude-Stratton Town Council	
Rev. B		-		
Rev. C		-	The Parkhouse Centre	
Rev. D		-	Bude	
Rev. E		-		
Rev. F		-	EX23 8LD	
Rev. G		-		
Rev. H		-		NOTE : FIGURED
Rev. I		-	Drawn: IB Checked: ??	REPORT ANY D
Rev. J		-		PROCE

STATUS: Subject to Building Control Approval

NOTE : FIGURED DIMENSIONS TO BE WORKED FROM ONLY.
REPORT ANY DISCREPANCIES TO THE SURVEYOR BEFORE
PROCEEDING. DO NOT SCALE DRAWING.



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Bude Pitch & Putt Proposed Sub Structure & Roof Layout Plan

 Scale:
 1:50
 Date: Nov 2016
 Rev

 Drawing Number:
 266/2014/010
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